



Lower Thames Crossing

2.6 Works Plans Volume B Composite (sheets 1 to 20) (Clean version)

APFP Regulation 5(2)(j)

Infrastructure Planning (Applications:
Prescribed Forms and Procedure)
Regulations 2009

Volume 2

DATE: December 2023
DEADLINE: 9

Planning Inspectorate Scheme Ref: TR010032
Application Document Ref: TR010032/APP/2.6

VERSION: 6.0

Revision history

Version	Date	Submitted at
1.0	31 October 2022	DCO Application
2.0	20 December 2022	Response to advice provided under section 51 of the Planning Act 2008 by the Planning Inspectorate
3.0	24 August 2023	Deadline 3
4.0	19 September 2023	Deadline 4
5.0	17 November 2023	Deadline 7
6.0	11 December 2023	Deadline 9

Lower Thames Crossing

2.6 Works Plans

Volume B Composite (sheets 1 to 20) (Clean version)

List of contents

	Page number
1 Introduction	1
2 Schedule of Plans included in this application document	6

1 Introduction

- 1.1.1 This document is submitted to the Planning Inspectorate on behalf of the Secretary of State in relation to an application made by National Highways (the Applicant) under section 37 of the Planning Act 2008.
- 1.1.2 The Application is for the grant of development consent for the A122 Lower Thames Crossing. Should development consent be granted, the draft A122 (Lower Thames Crossing) Development Consent Order (Application Document 3.1) (the draft Order") will be made by the Secretary of State for Transport (subject to any modifications considered appropriate).
- 1.1.3 This document comprises part of the suite of application documentation and is included in the application to comply with Regulations 5(2)(j) and 5(4) of the Infrastructure Planning (Applications: Prescribed Forms and Procedure) Regulations 2009, which require:
- 5(2)(j) '*a works plan showing, in relation to existing features:*
- (i) *the proposed location or (for a linear scheme) the proposed route and alignment of the development and works; and*
- (ii) *the limits within which the development and works may be carried out and any limits of deviation provided for in the draft order.*
- 5(4) *Where a plan comprises three or more separate sheets a key plan must be provided showing the relationship between the different sheets.'*
- 1.1.4 The purpose of the Works Plans is to illustrate the location and extent of the works for which development consent is sought as described in Schedule 1 of the draft Order (Application Document 3.1). The Applicant has sought to describe the works in Schedule 1 applying, whenever necessary, separate sub-work numbers to provide clarity.
- 1.1.5 In order to assist the interpretation of the Works Plans, the Applicant has prepared Composite sheets, which show all of the works for that sheet, and Utilities sheets, which show only the utility works from the Composite sheet.
- 1.1.6 It should be noted that, for consistency, the Applicant has prepared the Utilities sheets for the entire set.
- 1.1.7 As the Works Plans have been informed by and are part of the application documentation, they should be read alongside the other application documents. In particular, the Works Plans should be read alongside the following:
- Schedule 1 of the draft Order (Application Document 3.1)
 - Land Plans (Application Document 2.2)
 - Rights of Way and Access Plans (Application Document 2.7)
 - Engineering Drawings and Sections Plans (Application Document 2.9)
 - Structures Plans (Application Document 2.13)
 - Temporary Works Plans (Application Document 2.17)

- 1.1.8 Each sheet shows the relevant works numbers applicable within the area shown. Reference should be made to the next relevant sheet for details of works numbers beyond the cut lines. Other information on the Works Plans is shown beyond the cut lines for completeness and context.
- 1.1.9 The Works Plans show the Order Limits and the relevant local authority boundaries for clarity. In this plan set, ‘the Order Limits’ mean the limits of lands to be acquired or used, permanently or temporarily, within which the authorised development may be carried out (see article 2 of the draft Order (Application Document 3.1)).
- 1.1.10 The Works Plans show the centreline for each length of the proposed highway work or linear utility diversion, as well as the boundary for other non-linear works. The proposed highway works centreline is shown in a black dashed line and comprises the road works including streets, public rights of way and private means of access.
- 1.1.11 The proposed diversion or modification of overhead lines is shown in a purple solid line and the temporary diversion alignment is shown in a purple dashed line. The existing overhead lines to be removed as part of the works is shown in a grey dashed line. The proposed underground diversion alignment for gas is shown in an orange solid line and the proposed gas alignment to be removed is shown in orange dashed line. The proposed underground diversion alignment for multi-utilities is shown in blue solid line and the above ground multi-utility compounds are shown in a black box identified as ‘substation SS’. The proposed temporary underground diversion alignment for multi-utilities is shown in light blue solid line.
- 1.1.12 Start and end points for utilities works are not shown as the centreline and the limits of deviation represent the areas in which the works can be carried out, covering disparate elements of the works which are connected but which do not have the same start and end point. However, for gas utilities works, the alignment line is supported by solid orange squares (at each end) representing the tie-ins into the existing network, where applicable. Where there is no tie-in to the existing gas network no solid orange square is shown. For the overhead lines works, the alignment line includes (along its extent) purple border squares for new permanent pylons, purple dashed border squares for new temporary pylons, grey dashed border squares for existing pylons to be removed and green border squares for existing pylons to be retained. Additional power apparatus (such as poles) are not shown.
- 1.1.13 The major proposed structures are highlighted with a black solid box and include structures along the Project mainline and the ground protection tunnel. All these structures have been assigned their own work number, described in Schedule 1 of the draft Order (Application Document 3.1).
- 1.1.14 The Works Plans show the areas proposed in the environmental design as new areas to provide mitigation or compensation for the impacts of the Project as black arrow shaded areas. The areas necessary for floodplain compensation are shown as a blue dotted shaded area.
- 1.1.15 The Works Plans indicate the location of temporary construction compounds and working sites, listed as numbered works in Schedule 1. A separate set of Temporary Works Plans (Application Document 2.17) has been prepared to

show the location and extent of temporary works, including temporary roads for construction access.

- 1.1.16 The design is shown in the background on the Works Plans for illustrative purposes and specifically to provide context and aid understanding of the works. As indicated in the legend, the proposed structures are shown as two solid grey lines; this includes the proposed bridges, viaducts, overbridges, underbridges and retaining walls. It should be noted that proposed bridges, viaducts, overbridges and underbridges are described as a sub-work of a highways linear work in Schedule 1 of the draft Order (Application Document 3.1). For other elements of the works that cannot be separately distinguished from a work or broken down, such as retaining walls, highway drainage ditches and swales, embankments and cuttings earthworks, the Applicant has included these in the list of ancillary works as described in Schedule 1 of the draft Order (Application Document 3.1).
- 1.1.17 The proposed drainage culverts are represented in a specific way, as shown in the legend, in an approach consistent with the General Arrangement Plans (Application Document 2.5).
- 1.1.18 The commencement and termination of the proposed highways linear works are graphically represented on the plan by different black markers in the shape of bowties (one solid, one hollow). The Applicant has made every effort to represent the bowtie entirely within the Order Limits boundary wherever possible but due to the size of this graphic, this is sometimes unachievable. It is important to note that the start and end points of the works are all within the Order Limits and are defined by the reference points listed in Schedule 1 of the draft Order (Application Document 3.1) and shown in Rights of Way and Access Plans (Application Document 2.7).
- 1.1.19 Article 6 of the draft Order (Application Document 3.1) provides for a lateral deviation from the lines or situations shown on the Works Plans to the extent of the defined limits of deviation. This is to provide the Applicant with a limited and proportionate degree of flexibility to allow for detailed design development. The vertical limits of deviation are described in Article 6 of the draft Order (Application Document 3.1).
- 1.1.20 The highway works lateral limits of deviation are shown as areas of shaded green on the Composite sheets and the limits of deviation for utility works are indicated by striped areas on the Composite and Utilities sheets as: purple for overhead electricity lines works, orange for gas works, blue for underground multi-utility works and light blue for temporary overhead and multi-utility works. Where relevant, the lateral limits of deviation shown in the Works Plans have been determined considering a range of factors, including earthworks, structures and drainage features. The lateral limits of deviation for tunnels works, such as the tunnel portal structures (south and north), the bored tunnels and the tunnel service buildings are show as part of the highways lateral limits of deviation and also shown in detail in the Tunnel Limits of Deviation Plans (Application Document 2.15).
- 1.1.21 Further information about the limits of deviation is provided in the Introduction to the Application (Application Document 1.3). The information shown on the plans is for illustrative purposes only to show the proposed design of the Project and

would be subject to detailed design. Detailed design would be in accordance with the extent of the defined limits of deviation provided in the draft Order and any approval required under the requirements set out in Schedule 2 of the draft Order (Application Document 3.1).

- 1.1.22 It should be recognised that there are some instances where the extent of a work shown in the Works Plans and described in Schedule 1 of the draft Order (Application Document 3.1) may differ from the extents provided elsewhere in the draft Order, namely in Schedules 3 and 4 (Application Document 3.1). This is because, in some cases, new public rights of way may be created by a combination of works or the creation of a new public rights of way may be divided into several works. The corresponding commencement and termination points of all the works shown in the Works Plans have a corresponding reference point in the Rights of Way and Access Plans (Application Document 2.7).
- 1.1.23 To ensure sufficient detail and clarity of information, the Works Plans (sheets 1 to 49) have been prepared at a scale of 1:2500. The key plan uses a smaller scale than that prescribed in Regulation 5(3) of the 2009 Regulations so that the Project can be represented in a single sheet plan.
- 1.1.24 The Applicant has adopted the same approach for the Works Plans as has been used for the following:
- a. Land Plans (Application Document 2.2)
 - b. Crown Land Plans (Application Document 2.3)
 - c. Special Category Land Plans (Application Document 2.4)
 - d. General Arrangement Plans (Application Document 2.5)
 - e. Rights of Way and Access Plans (Application Document 2.7)
 - f. Streets Subject to Temporary Restrictions of Use Plans (Application Document 2.8)
 - g. Traffic Regulation Measures Plans (Application Document 2.10)
 - h. Drainage Plans (Application Document 2.16)
 - i. Temporary Works Plans (Application Document 2.17)
 - j. Hedgerows and Tree Preservation Order Plans (Application Document 2.18)
- 1.1.25 The information contained on each sheet of the Works Plans corresponds with the information shown on each sheet of the aforementioned sets. This is intended to help interested parties understand the inter-relationship between the different sets of plans and to help illustrate the design of the Project more clearly.
- 1.1.26 It is important to note that there are locations within the DCO boundary where no works are shown on the Works Plans. A number of reasons could account

for this, for example, the land may be required temporarily to provide sufficient working space during construction.

- 1.1.27 This plan set uses a consistent key applicable to the plan set as a whole, rather than being tailored to each individual sheet. This means that there may be some items shown in the key that are not on a given sheet.
- 1.1.28 To ensure that the file size of this document does not exceed the 50MB limit prescribed by the Planning Inspectorate, the set has been split into six volumes: three separate volumes (volume A contains the key plan, volume B contains the initial sheets 1 to 20 and volume C contains sheets 21 to 49 for the composite plans) and three further separate volumes (volumes A, B and C) for the utilities works.
- 1.1.29 These plans have been updated for Deadline 3 to include the minor amendments as advised by the Examining Authority in Rule 9 [\[PD-022\]](#).
- 1.1.30 These plans have been updated for Deadline 4 to include the proposed changes MRC01, MRC02 and MRC03 following the procedural decision made by the Examining Authority [\[PD-031\]](#).
- 1.1.31 These plans have been updated for Deadline 7 to include the proposed amendment EA07, as detailed in Deadline 5 cover letter [\[REP5-001\]](#), and proposed amendments EA08 and EA10, as explained in the Applicant's Amendment Letter [\[REP6A-023\]](#). These plans also include the proposed change EC03 following the procedural decision made by the Examining Authority [\[PD-045\]](#).
- 1.1.32 These plans have been updated for Deadline 9 to include all agreed proposed changes and amendments throughout Examination.

2

Schedule of Plans included in this application document

Document Title	Document Number	Revision
WORKS PLANS REGULATION 5(2)(j) KEY PLAN – COMPOSITE	TR010032/APP/2.6	P05
WORKS PLANS REGULATION 5(2)(j) SHEET 1 – COMPOSITE	TR010032/APP/2.6	P03
WORKS PLANS REGULATION 5(2)(j) SHEET 2 – COMPOSITE	TR010032/APP/2.6	P03
WORKS PLANS REGULATION 5(2)(j) SHEET 3 – COMPOSITE	TR010032/APP/2.6	P02
WORKS PLANS REGULATION 5(2)(j) SHEET 4 – COMPOSITE	TR010032/APP/2.6	P04
WORKS PLANS REGULATION 5(2)(j) SHEET 5 – COMPOSITE	TR010032/APP/2.6	P02
WORKS PLANS REGULATION 5(2)(j) SHEET 6 – COMPOSITE	TR010032/APP/2.6	P04
WORKS PLANS REGULATION 5(2)(j) SHEET 7 – COMPOSITE	TR010032/APP/2.6	P02
WORKS PLANS REGULATION 5(2)(j) SHEET 8 – COMPOSITE	TR010032/APP/2.6	P02
WORKS PLANS REGULATION 5(2)(j) SHEET 9 – COMPOSITE	TR010032/APP/2.6	P02
WORKS PLANS REGULATION 5(2)(j) SHEET 10 – COMPOSITE	TR010032/APP/2.6	P02

Document Title	Document Number	Revision
WORKS PLANS REGULATION 5(2)(j) SHEET 11 – COMPOSITE	TR010032/APP/2.6	P05
WORKS PLANS REGULATION 5(2)(j) SHEET 12 – COMPOSITE	TR010032/APP/2.6	P03
WORKS PLANS REGULATION 5(2)(j) SHEET 13 – COMPOSITE	TR010032/APP/2.6	P03
WORKS PLANS REGULATION 5(2)(j) SHEET 14 – COMPOSITE	TR010032/APP/2.6	P03
WORKS PLANS REGULATION 5(2)(j) SHEET 15 – COMPOSITE	TR010032/APP/2.6	P03
WORKS PLANS REGULATION 5(2)(j) SHEET 16 – COMPOSITE	TR010032/APP/2.6	P02
WORKS PLANS REGULATION 5(2)(j) SHEET 17 – COMPOSITE	TR010032/APP/2.6	P03
WORKS PLANS REGULATION 5(2)(j) SHEET 18 – COMPOSITE	TR010032/APP/2.6	P02
WORKS PLANS REGULATION 5(2)(j) SHEET 19 – COMPOSITE	TR010032/APP/2.6	P02
WORKS PLANS REGULATION 5(2)(j) SHEET 20 – COMPOSITE	TR010032/APP/2.6	P03
WORKS PLANS REGULATION 5(2)(j) SHEET 21 – COMPOSITE	TR010032/APP/2.6	P03
WORKS PLANS REGULATION 5(2)(j) SHEET 22 – COMPOSITE	TR010032/APP/2.6	P05
WORKS PLANS REGULATION 5(2)(j) SHEET 23 – COMPOSITE	TR010032/APP/2.6	

Document Title	Document Number	Revision
WORKS PLANS REGULATION 5(2)(j) SHEET 24 – COMPOSITE	TR010032/APP/2.6	P04
WORKS PLANS REGULATION 5(2)(j) SHEET 25 – COMPOSITE	TR010032/APP/2.6	P02
WORKS PLANS REGULATION 5(2)(j) SHEET 26 – COMPOSITE	TR010032/APP/2.6	P02
WORKS PLANS REGULATION 5(2)(j) SHEET 27 – COMPOSITE	TR010032/APP/2.6	P02
WORKS PLANS REGULATION 5(2)(j) SHEET 28 – COMPOSITE	TR010032/APP/2.6	P04
WORKS PLANS REGULATION 5(2)(j) SHEET 29 – COMPOSITE	TR010032/APP/2.6	P03
WORKS PLANS REGULATION 5(2)(j) SHEET 30 – COMPOSITE	TR010032/APP/2.6	P02
WORKS PLANS REGULATION 5(2)(j) SHEET 31 – COMPOSITE	TR010032/APP/2.6	P03
WORKS PLANS REGULATION 5(2)(j) SHEET 32 – COMPOSITE	TR010032/APP/2.6	P03
WORKS PLANS REGULATION 5(2)(j) SHEET 33 – COMPOSITE	TR010032/APP/2.6	P03
WORKS PLANS REGULATION 5(2)(j) SHEET 34 – COMPOSITE	TR010032/APP/2.6	P03
WORKS PLANS REGULATION 5(2)(j) SHEET 35 – COMPOSITE	TR010032/APP/2.6	P03
WORKS PLANS REGULATION 5(2)(j) SHEET 36 – COMPOSITE	TR010032/APP/2.6	P02


Document Title	Document Number	Revision
WORKS PLANS REGULATION 5(2)(j) SHEET 37 – COMPOSITE	TR010032/APP/2.6	P02
WORKS PLANS REGULATION 5(2)(j) SHEET 38 – COMPOSITE	TR010032/APP/2.6	P03
WORKS PLANS REGULATION 5(2)(j) SHEET 39 – COMPOSITE	TR010032/APP/2.6	P03
WORKS PLANS REGULATION 5(2)(j) SHEET 40 – COMPOSITE	TR010032/APP/2.6	P03
WORKS PLANS REGULATION 5(2)(j) SHEET 41 – COMPOSITE	TR010032/APP/2.6	P02
WORKS PLANS REGULATION 5(2)(j) SHEET 42 – COMPOSITE	TR010032/APP/2.6	P02
WORKS PLANS REGULATION 5(2)(j) SHEET 43 – COMPOSITE	TR010032/APP/2.6	P03
WORKS PLANS REGULATION 5(2)(j) SHEET 44 – COMPOSITE	TR010032/APP/2.6	P02
WORKS PLANS REGULATION 5(2)(j) SHEET 45 – COMPOSITE	TR010032/APP/2.6	P04
WORKS PLANS REGULATION 5(2)(j) SHEET 46 – COMPOSITE	TR010032/APP/2.6	P02
WORKS PLANS REGULATION 5(2)(j) SHEET 47 – COMPOSITE	TR010032/APP/2.6	P03
WORKS PLANS REGULATION 5(2)(j) SHEET 48 – COMPOSITE	TR010032/APP/2.6	P02
WORKS PLANS REGULATION 5(2)(j) SHEET 49 – COMPOSITE	TR010032/APP/2.6	P02

Document Title	Document Number	Revision
WORKS PLANS REGULATION 5(2)(j) KEY PLAN – UTILITIES	TR010032/APP/2.6	P05
WORKS PLANS REGULATION 5(2)(j) SHEET 1 – UTILITIES	TR010032/APP/2.6	P03
WORKS PLANS REGULATION 5(2)(j) SHEET 2 – UTILITIES	TR010032/APP/2.6	P03
WORKS PLANS REGULATION 5(2)(j) SHEET 3 – UTILITIES	TR010032/APP/2.6	P02
WORKS PLANS REGULATION 5(2)(j) SHEET 4 – UTILITIES	TR010032/APP/2.6	P04
WORKS PLANS REGULATION 5(2)(j) SHEET 5 – UTILITIES	TR010032/APP/2.6	P02
WORKS PLANS REGULATION 5(2)(j) SHEET 6 – UTILITIES	TR010032/APP/2.6	P03
WORKS PLANS REGULATION 5(2)(j) SHEET 7 – UTILITIES	TR010032/APP/2.6	P02
WORKS PLANS REGULATION 5(2)(j) SHEET 8 – UTILITIES	TR010032/APP/2.6	P02
WORKS PLANS REGULATION 5(2)(j) SHEET 9 – UTILITIES	TR010032/APP/2.6	P02
WORKS PLANS REGULATION 5(2)(j) SHEET 10 – UTILITIES	TR010032/APP/2.6	P02
WORKS PLANS REGULATION 5(2)(j) SHEET 11 – UTILITIES	TR010032/APP/2.6	P02
WORKS PLANS REGULATION 5(2)(j) SHEET 12 – UTILITIES	TR010032/APP/2.6	P03

Document Title	Document Number	Revision
WORKS PLANS REGULATION 5(2)(j) SHEET 13 – UTILITIES	TR010032/APP/2.6	P02
WORKS PLANS REGULATION 5(2)(j) SHEET 14 – UTILITIES	TR010032/APP/2.6	P02
WORKS PLANS REGULATION 5(2)(j) SHEET 15 – UTILITIES	TR010032/APP/2.6	P02
WORKS PLANS REGULATION 5(2)(j) SHEET 16 – UTILITIES	TR010032/APP/2.6	P02
WORKS PLANS REGULATION 5(2)(j) SHEET 17 – UTILITIES	TR010032/APP/2.6	P03
WORKS PLANS REGULATION 5(2)(j) SHEET 18 – UTILITIES	TR010032/APP/2.6	P02
WORKS PLANS REGULATION 5(2)(j) SHEET 19 – UTILITIES	TR010032/APP/2.6	P02
WORKS PLANS REGULATION 5(2)(j) SHEET 20 – UTILITIES	TR010032/APP/2.6	P02
WORKS PLANS REGULATION 5(2)(j) SHEET 21 – UTILITIES	TR010032/APP/2.6	P03
WORKS PLANS REGULATION 5(2)(j) SHEET 22 – UTILITIES	TR010032/APP/2.6	P03
WORKS PLANS REGULATION 5(2)(j) SHEET 23 – UTILITIES	TR010032/APP/2.6	P04
WORKS PLANS REGULATION 5(2)(j) SHEET 24 – UTILITIES	TR010032/APP/2.6	P03
WORKS PLANS REGULATION 5(2)(j) SHEET 25 – UTILITIES	TR010032/APP/2.6	P02

Document Title	Document Number	Revision
WORKS PLANS REGULATION 5(2)(j) SHEET 26 – UTILITIES	TR010032/APP/2.6	P02
WORKS PLANS REGULATION 5(2)(j) SHEET 27 – UTILITIES	TR010032/APP/2.6	P02
WORKS PLANS REGULATION 5(2)(j) SHEET 28 – UTILITIES	TR010032/APP/2.6	P02
WORKS PLANS REGULATION 5(2)(j) SHEET 29 – UTILITIES	TR010032/APP/2.6	P02
WORKS PLANS REGULATION 5(2)(j) SHEET 30 – UTILITIES	TR010032/APP/2.6	P02
WORKS PLANS REGULATION 5(2)(j) SHEET 31 – UTILITIES	TR010032/APP/2.6	P02
WORKS PLANS REGULATION 5(2)(j) SHEET 32 – UTILITIES	TR010032/APP/2.6	P03
WORKS PLANS REGULATION 5(2)(j) SHEET 33 – UTILITIES	TR010032/APP/2.6	P02
WORKS PLANS REGULATION 5(2)(j) SHEET 34 – UTILITIES	TR010032/APP/2.6	P02
WORKS PLANS REGULATION 5(2)(j) SHEET 35 – UTILITIES	TR010032/APP/2.6	P02
WORKS PLANS REGULATION 5(2)(j) SHEET 36 – UTILITIES	TR010032/APP/2.6	P02
WORKS PLANS REGULATION 5(2)(j) SHEET 37 – UTILITIES	TR010032/APP/2.6	P02
WORKS PLANS REGULATION 5(2)(j) SHEET 38 – UTILITIES	TR010032/APP/2.6	P03

Document Title	Document Number	Revision
WORKS PLANS REGULATION 5(2)(j) SHEET 39 – UTILITIES	TR010032/APP/2.6	P03
WORKS PLANS REGULATION 5(2)(j) SHEET 40 – UTILITIES	TR010032/APP/2.6	P03
WORKS PLANS REGULATION 5(2)(j) SHEET 41 – UTILITIES	TR010032/APP/2.6	P02
WORKS PLANS REGULATION 5(2)(j) SHEET 42 – UTILITIES	TR010032/APP/2.6	P02
WORKS PLANS REGULATION 5(2)(j) SHEET 43 – UTILITIES	TR010032/APP/2.6	P02
WORKS PLANS REGULATION 5(2)(j) SHEET 44 – UTILITIES	TR010032/APP/2.6	P02
WORKS PLANS REGULATION 5(2)(j) SHEET 45 – UTILITIES	TR010032/APP/2.6	P02
WORKS PLANS REGULATION 5(2)(j) SHEET 46 – UTILITIES	TR010032/APP/2.6	P02
WORKS PLANS REGULATION 5(2)(j) SHEET 47 – UTILITIES	TR010032/APP/2.6	P02
WORKS PLANS REGULATION 5(2)(j) SHEET 48 – UTILITIES	TR010032/APP/2.6	P02
WORKS PLANS REGULATION 5(2)(j) SHEET 49 – UTILITIES	TR010032/APP/2.6	P02

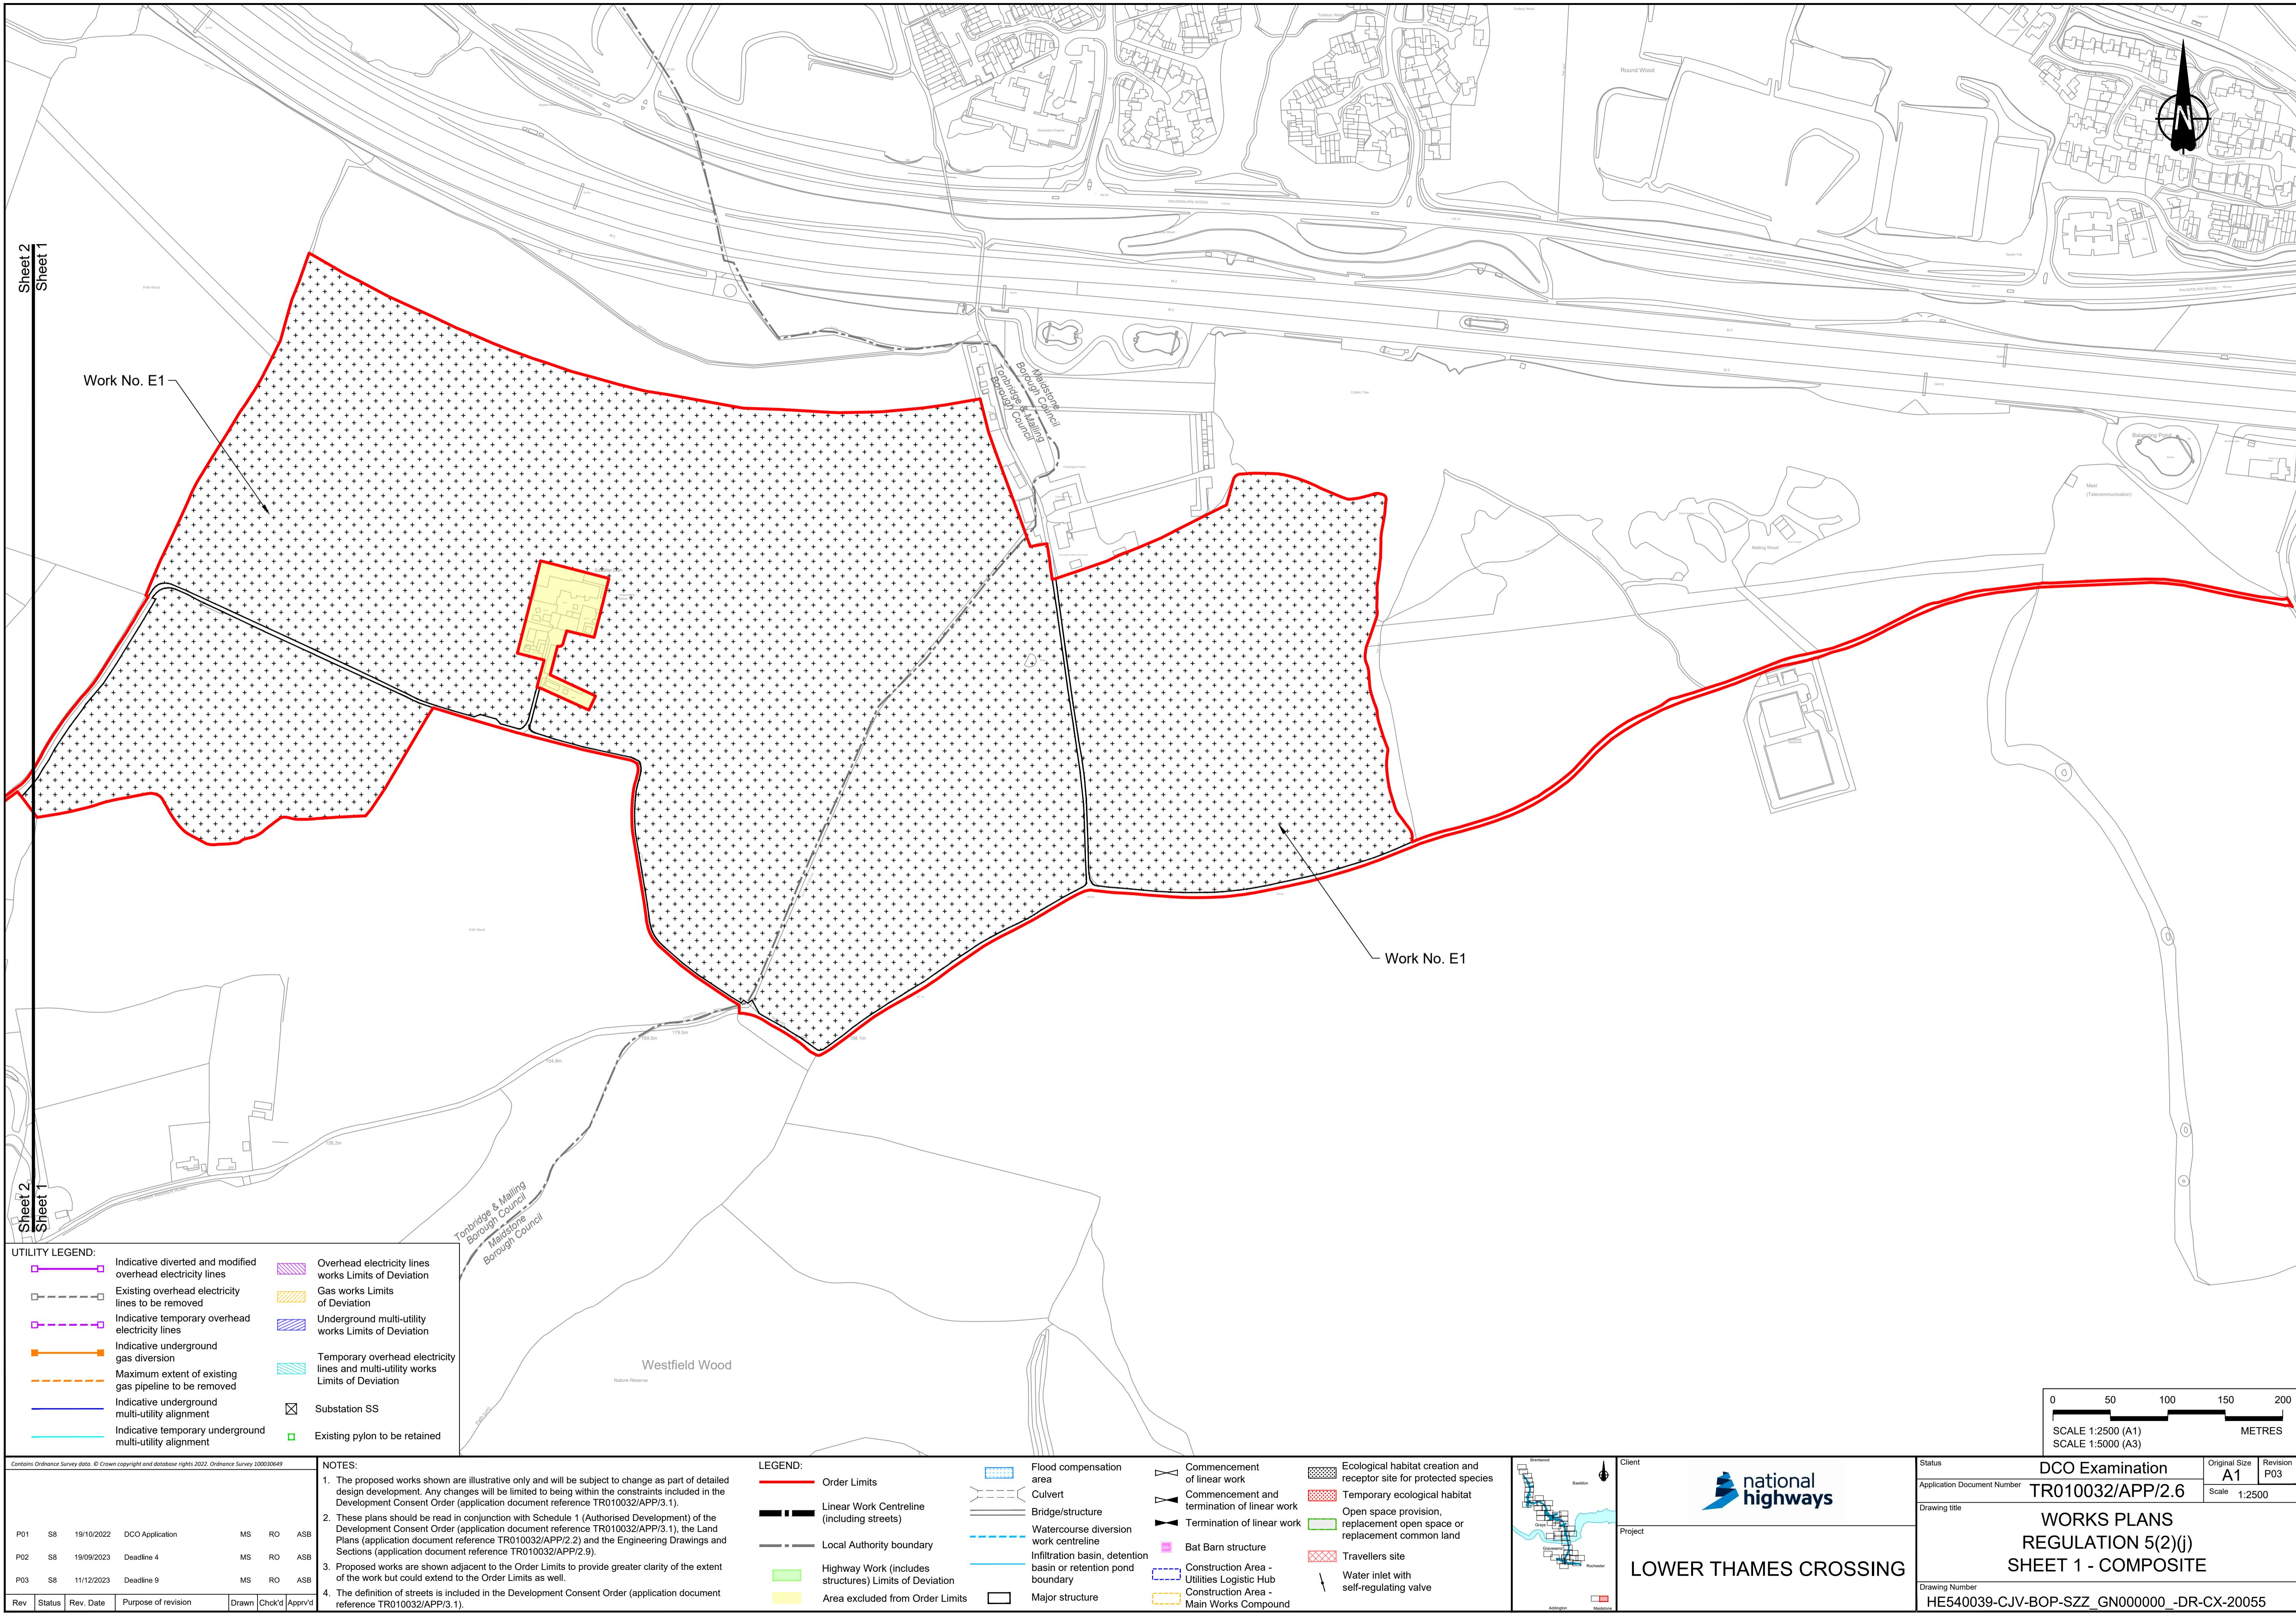





Contains Ordnance Survey data. © Crown copyright and database rights 2022. Ordnance Survey 100030649						
NOTES:						
P01	S8	19/10/2022	DCO Application	MS	RO	ASB
P02	S8	19/09/2023	Deadline 4	MS	RO	ASB
P03	S8	11/12/2023	Deadline 9	MS	RO	ASB
Rev	Status	Rev. Date	Purpose of revision	Drawn	Chk'd	Apprv'd

1. The proposed works shown are illustrative only and will be subject to change as part of detailed design development. Any changes will be limited to being within the constraints included in the Development Consent Order (application document reference TR010032/APP/3.1).
2. These plans should be read in conjunction with Schedule 1 (Authorised Development) of the Development Consent Order (application document reference TR010032/APP/2.2) and the Land Plans (application document reference TR010032/APP/3.1), the Engineering Drawings and Sections (application document reference TR010032/APP/2.9).
3. Proposed works are shown adjacent to the Order Limits to provide greater clarity of the extent of the work but could extend to the Order Limits as well.
4. The definition of streets is included in the Development Consent Order (application document reference TR010032/APP/3.1).

LEGEND:

Order Limits	Flood compensation area	Commencement of linear work	Ecological habitat creation and receptor site for protected species
Linear Work Centreline (including streets)	Culvert	Commencement and termination of linear work	Temporary ecological habitat
Local Authority boundary	Bridge/structure	Termination of linear work	Open space provision, replacement open space or replacement common land
Highway Work (includes structures) Limits of Deviation	Watercourse diversion work centreline	Bat Barn structure	Travellers site
	Infiltration basin, detention basin or retention pond boundary	Construction Area - Utilities Logistic Hub	Water inlet with self-regulating valve
	Area excluded from Order Limits	Construction Area - Main Works Compound	

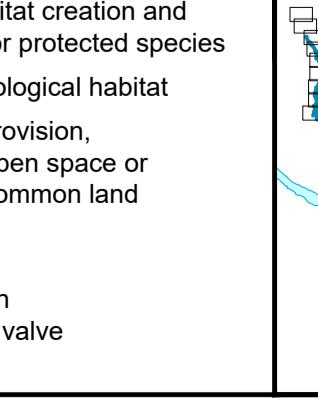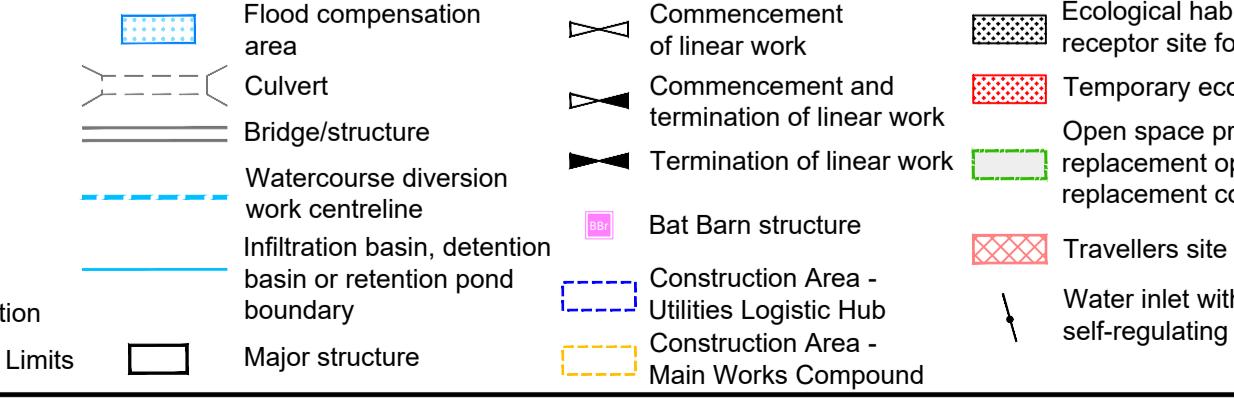


Client



Status

DCO Examination
Application Document Number: TR010032/APP/2.6
Scale: 1:2500
WORKS PLANS
REGULATION 5(2)(j)
SHEET 2 - COMPOSITE
Drawing Number: HE540039-CJV-BOP-SZZ_GN000000_DR-CX-20056

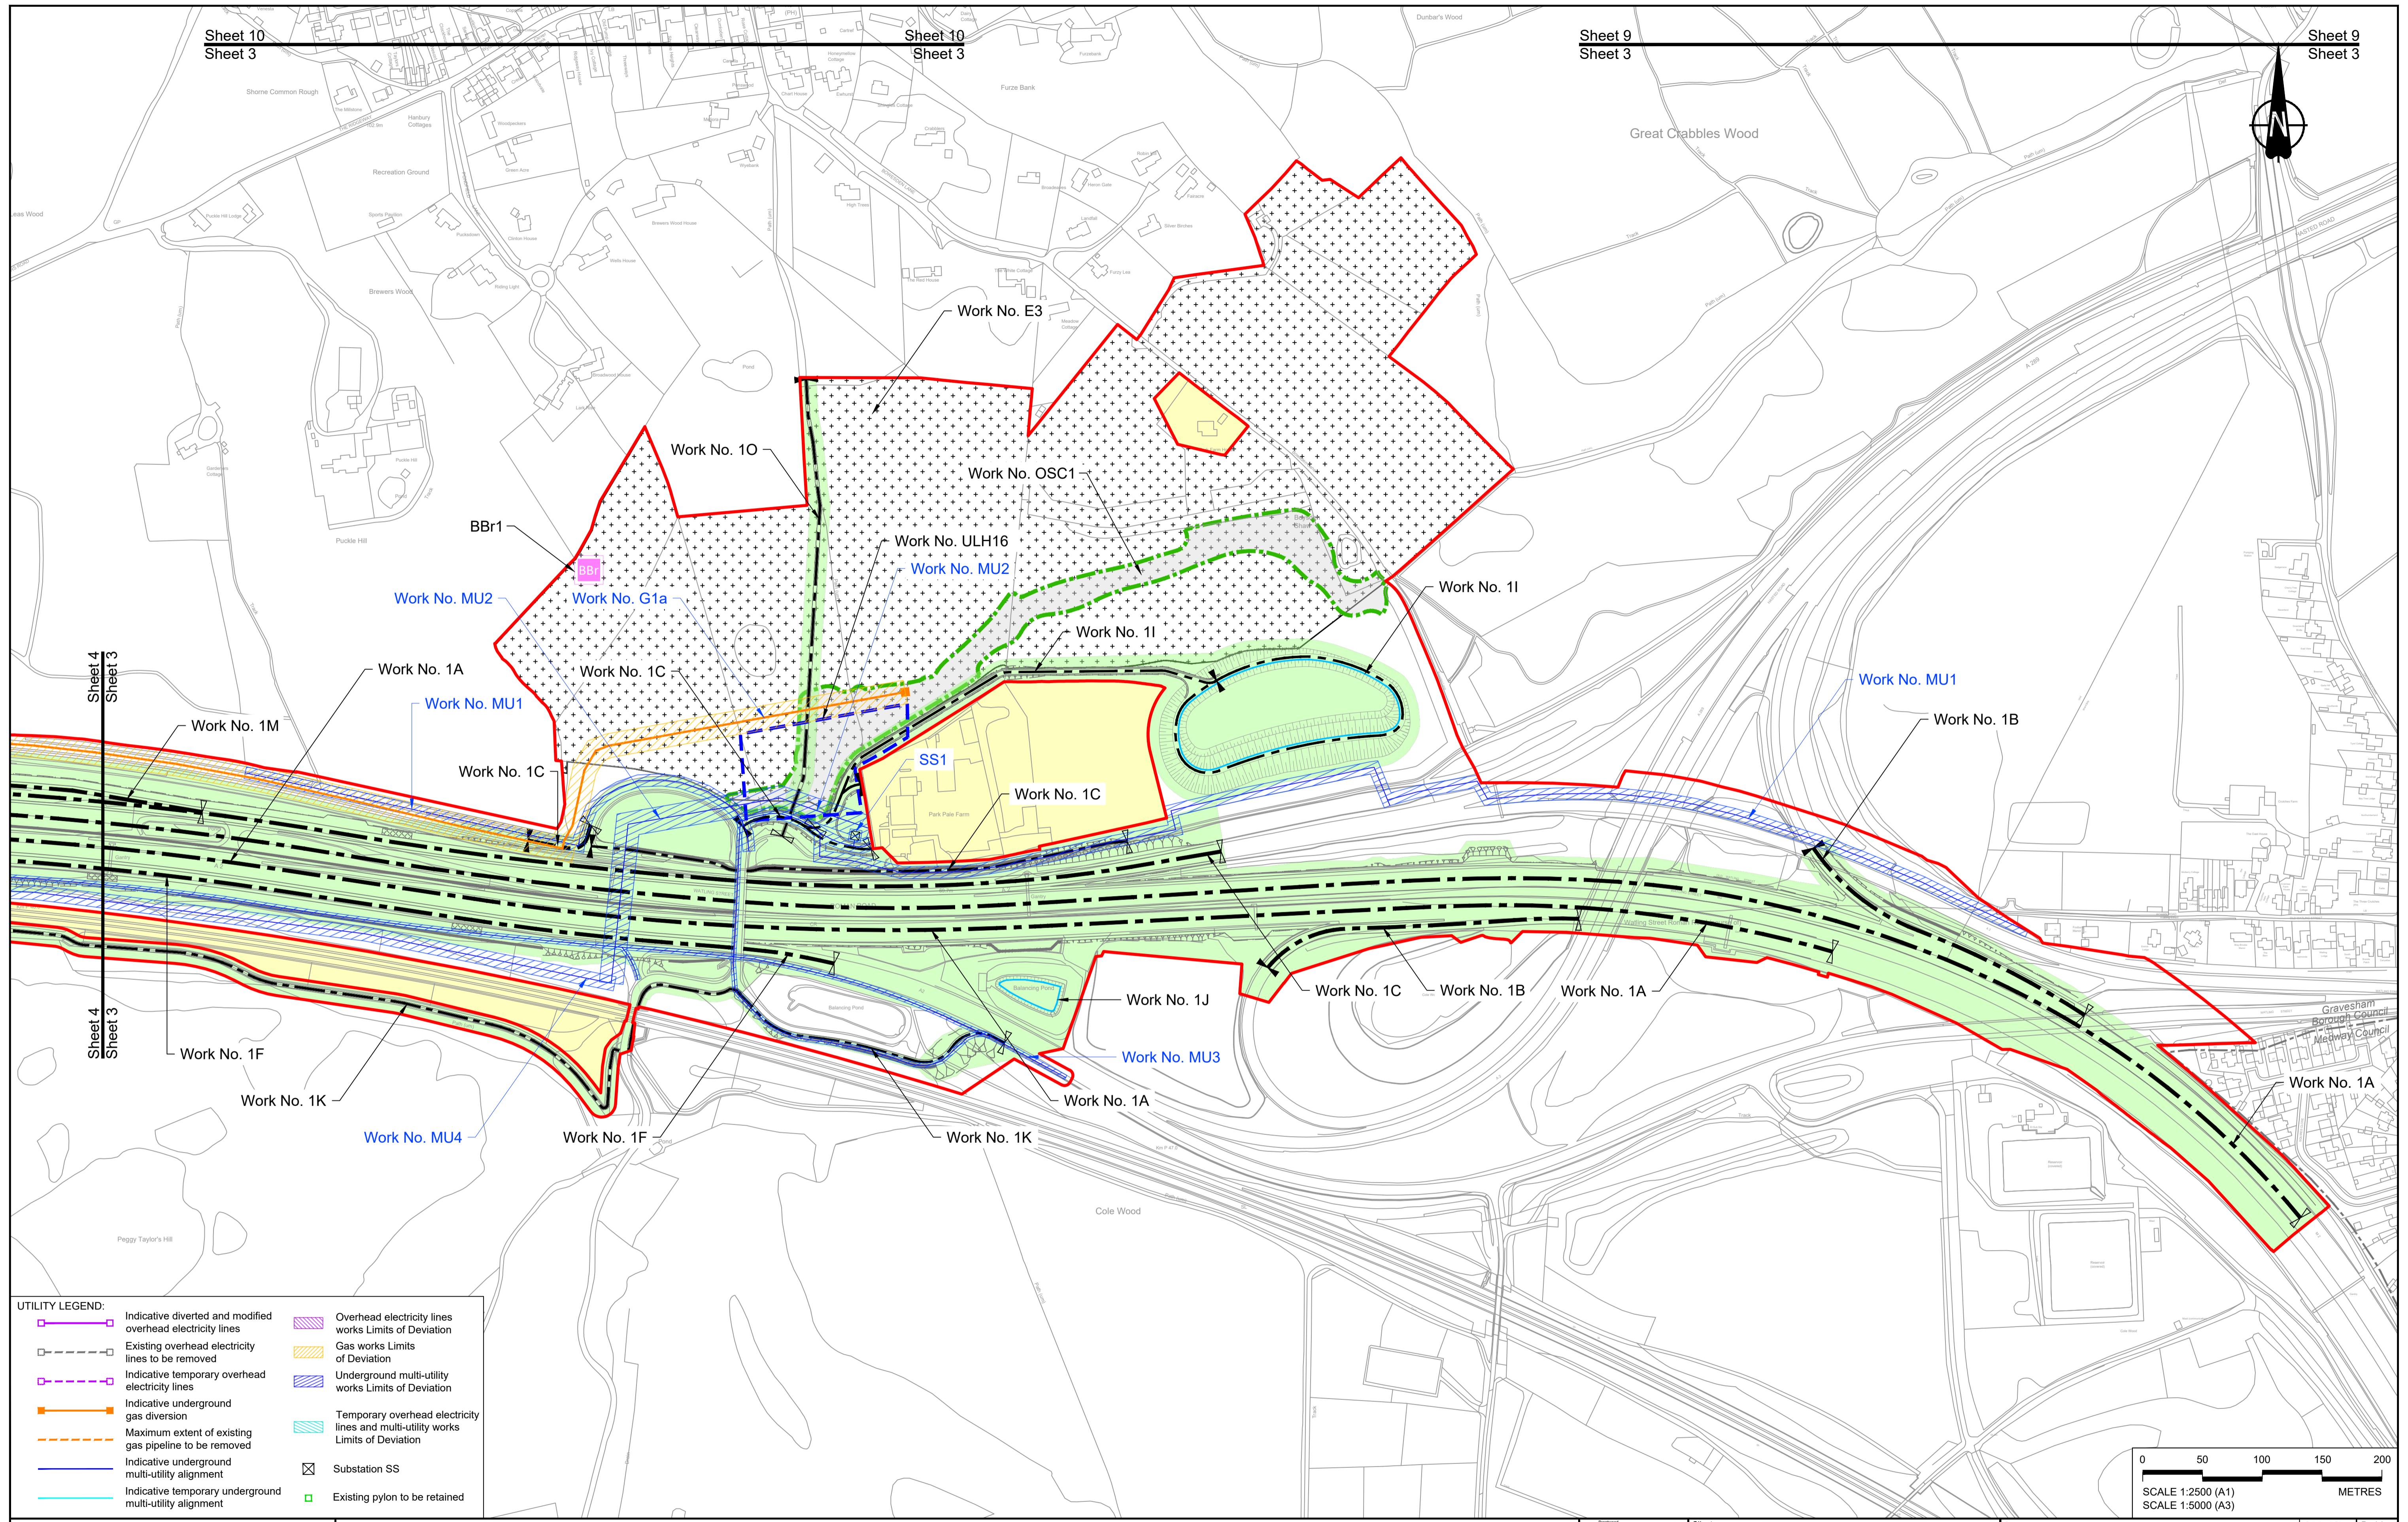

Contains Ordnance Survey data. © Crown copyright and database rights 2022. Ordnance Survey 100030649

- NOTES:**

 1. The proposed works shown are illustrative only and will be subject to change as part of detailed design development. Any changes will be limited to being within the constraints included in the Development Consent Order (application document reference TR010032/APP/3.1).
 2. These plans should be read in conjunction with Schedule 1 (Authorised Development) of the Development Consent Order (application document reference TR010032/APP/3.1), the Land Plans (application document reference TR010032/APP/2.2) and the Engineering Drawings and Sections (application document reference TR010032/APP/2.9).
 3. Proposed works are shown adjacent to the Order Limits to provide greater clarity of the extent of the work but could extend to the Order Limits as well.
 4. The definition of streets is included in the Development Consent Order (application document reference TR010032/APP/3.1).

LEGEND:


- Limits
- Work Centreline
(ing streets)
- Authority boundary
- ay Work (includes
res) Limits of Deviation
- xcluded from Order Li

A small square icon containing a grid of blue dots, representing a compensation or correction mechanism.

Flood compens.

- The legend contains the following entries:

 - Commencement of linear work**: Represented by a black triangle pointing right.
 - Commencement and termination of linear work**: Represented by a black triangle pointing right followed by a black triangle pointing left.
 - Termination of linear work**: Represented by a black triangle pointing left.
 - Bat Barn structure**: Represented by a pink square.
 - Construction Area - Utilities Logistic Hub**: Represented by a blue dashed rectangle.
 - Construction Area - Main Works Compound**: Represented by an orange dashed rectangle.
 - Ecological habitat creation and receptor site for protected species**: Represented by a grey dotted rectangle.
 - Temporary ecological habitat**: Represented by a red dotted rectangle.
 - Open space provision, replacement open space or replacement common land**: Represented by a green dashed rectangle.
 - Travellers site**: Represented by a red hatched rectangle.
 - Water inlet with self-regulating valve**: Represented by a black line with a small vertical tick mark.

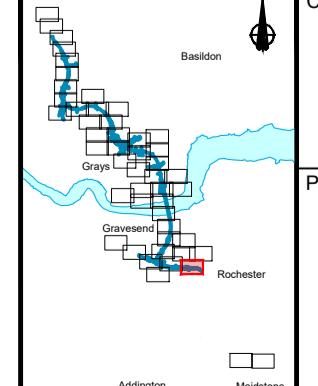


client

 national
highways

POWER THAMES CRO

Status	DCO Examination		Origin A
Application Document Number	TR010032/APP/2.6		Scale
Drawing title	WORKS PLANS REGULATION 5(2)(j) SHEET 3 - COMPOSITE		

Drawing Number
HE540039-CJV-BOP-SZZ GN000000 -DR-CX-20001

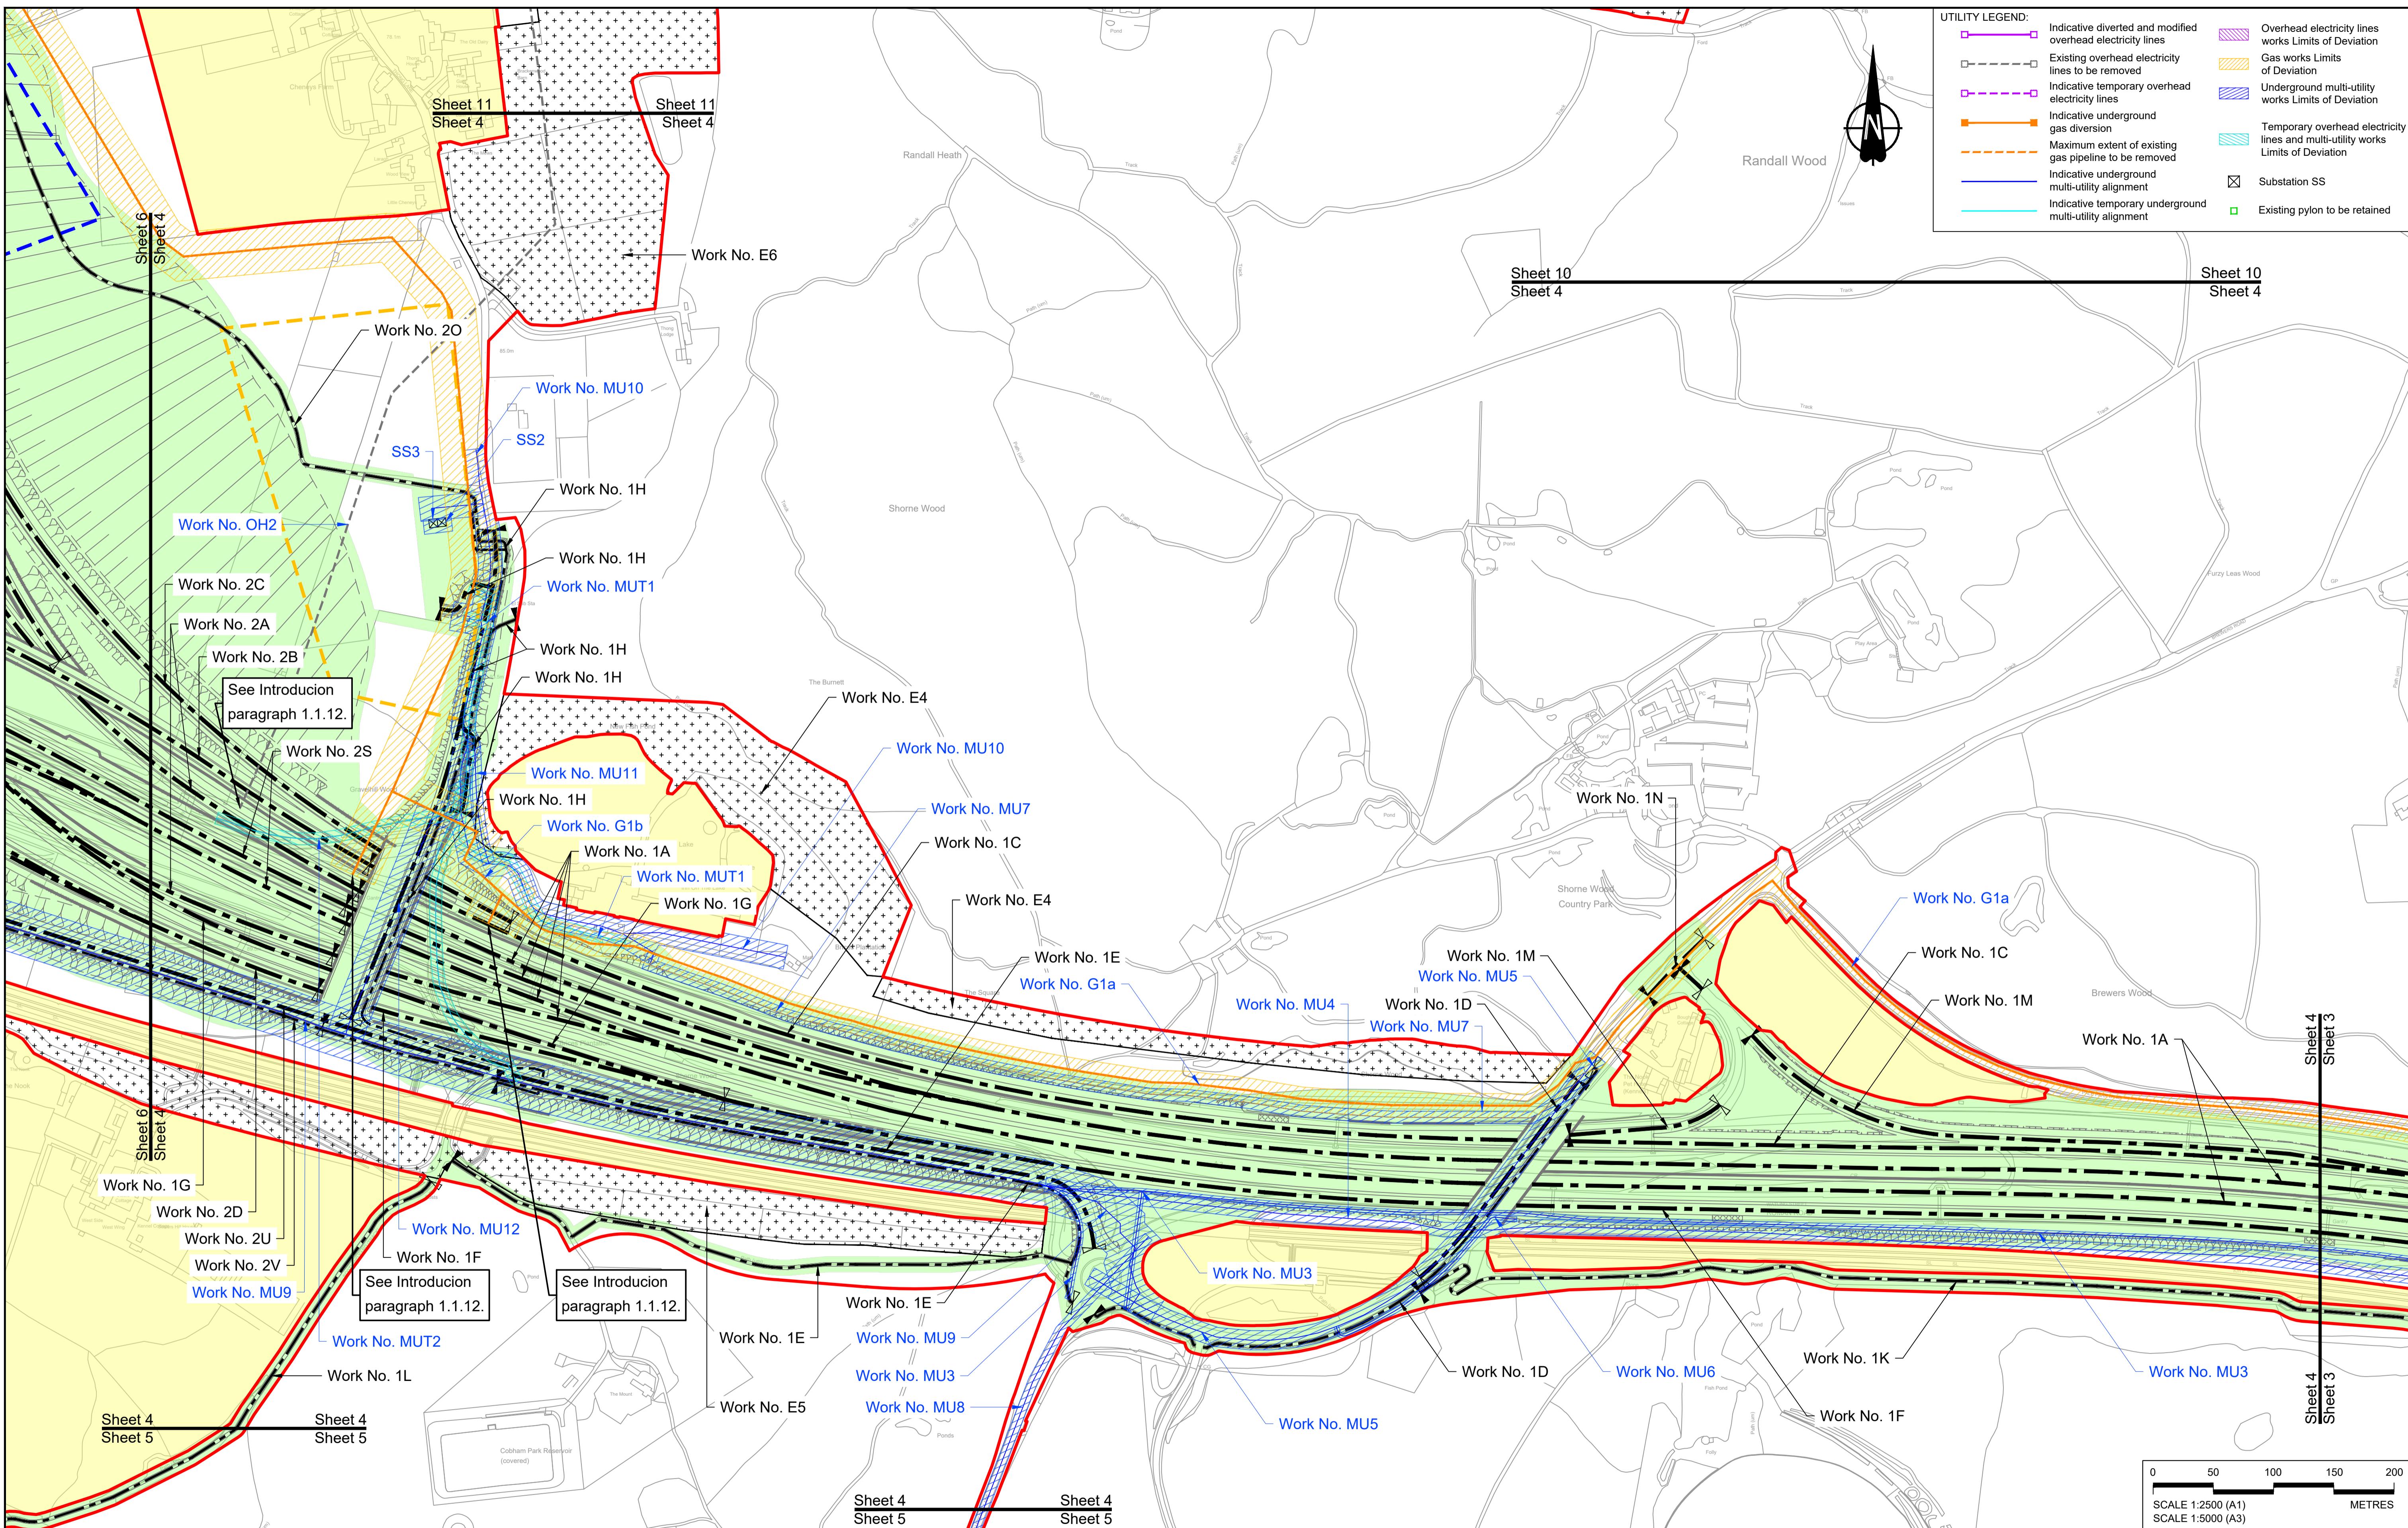



Contains Ordnance Survey data. © Crown copyright and database rights 2022. Ordnance Survey 100030649

P01	S8	19/10/2022	DCO Application	MS	RO	ASB
P02	S8	13/12/2022	Revision following S51 advice	MS	RO	ASB
P03	S8	17/11/2023	Deadline 7	MS	RO	ASB
P04	S8	11/12/2023	Deadline 9	MS	RO	ASB

- NOTES:**
- The proposed works shown are illustrative only and will be subject to change as part of detailed design development. Any changes will be limited to being within the constraints included in the Development Consent Order (application document reference TR010032/APP/3.1).
 - These plans should be read in conjunction with Schedule 1 (Authorised Development) of the Development Consent Order (application document reference TR010032/APP/2.2) and the Engineering Drawings and Sections (application document reference TR010032/APP/2.9).
 - Proposed works are shown adjacent to the Order Limits to provide greater clarity of the extent of the work but could extend to the Order Limits as well.
 - The definition of streets is included in the Development Consent Order (application document reference TR010032/APP/3.1).

LEGEND:

Order Limits	Flood compensation area	Commencement of linear work	Ecological habitat creation and receptor site for protected species
Linear Work Centreline (including streets)	Culvert	Commencement and termination of linear work	Temporary ecological habitat
Local Authority boundary	Bridge/structure	Termination of linear work	Open space provision, replacement open space or replacement common land
Highway Work (includes structures) Limits of Deviation	Watercourse diversion work centreline	Bat Barn structure	Travellers site
Area excluded from Order Limits	Infiltration basin, detention basin or retention pond boundary	Construction Area - Utilities Logistic Hub	Water inlet with self-regulating valve
	Major structure	Construction Area - Main Works Compound	

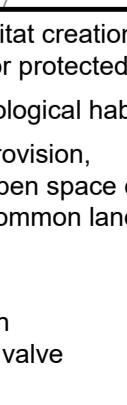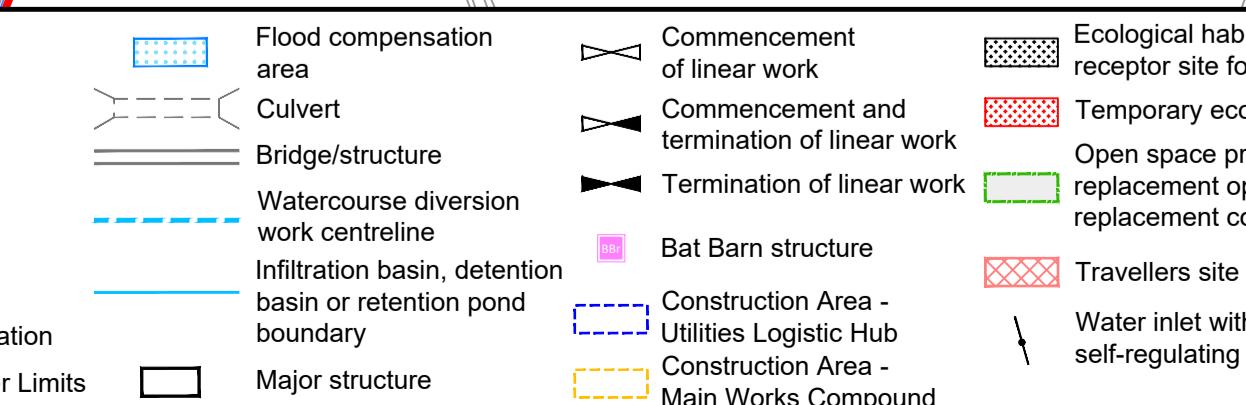


Client



DCO Examination
Application Document Number: TR010032/APP/2.6
Scale: 1:2500

Drawing title: WORKS PLANS
Project: REGULATION 5(2)(j)
Drawing Number: HE540039-CJV-BOP-SZZ_GN000000_DR-CX-20002
Status: A1
Original Size: A1
Revision: P04

LOWER THAMES CROSSING

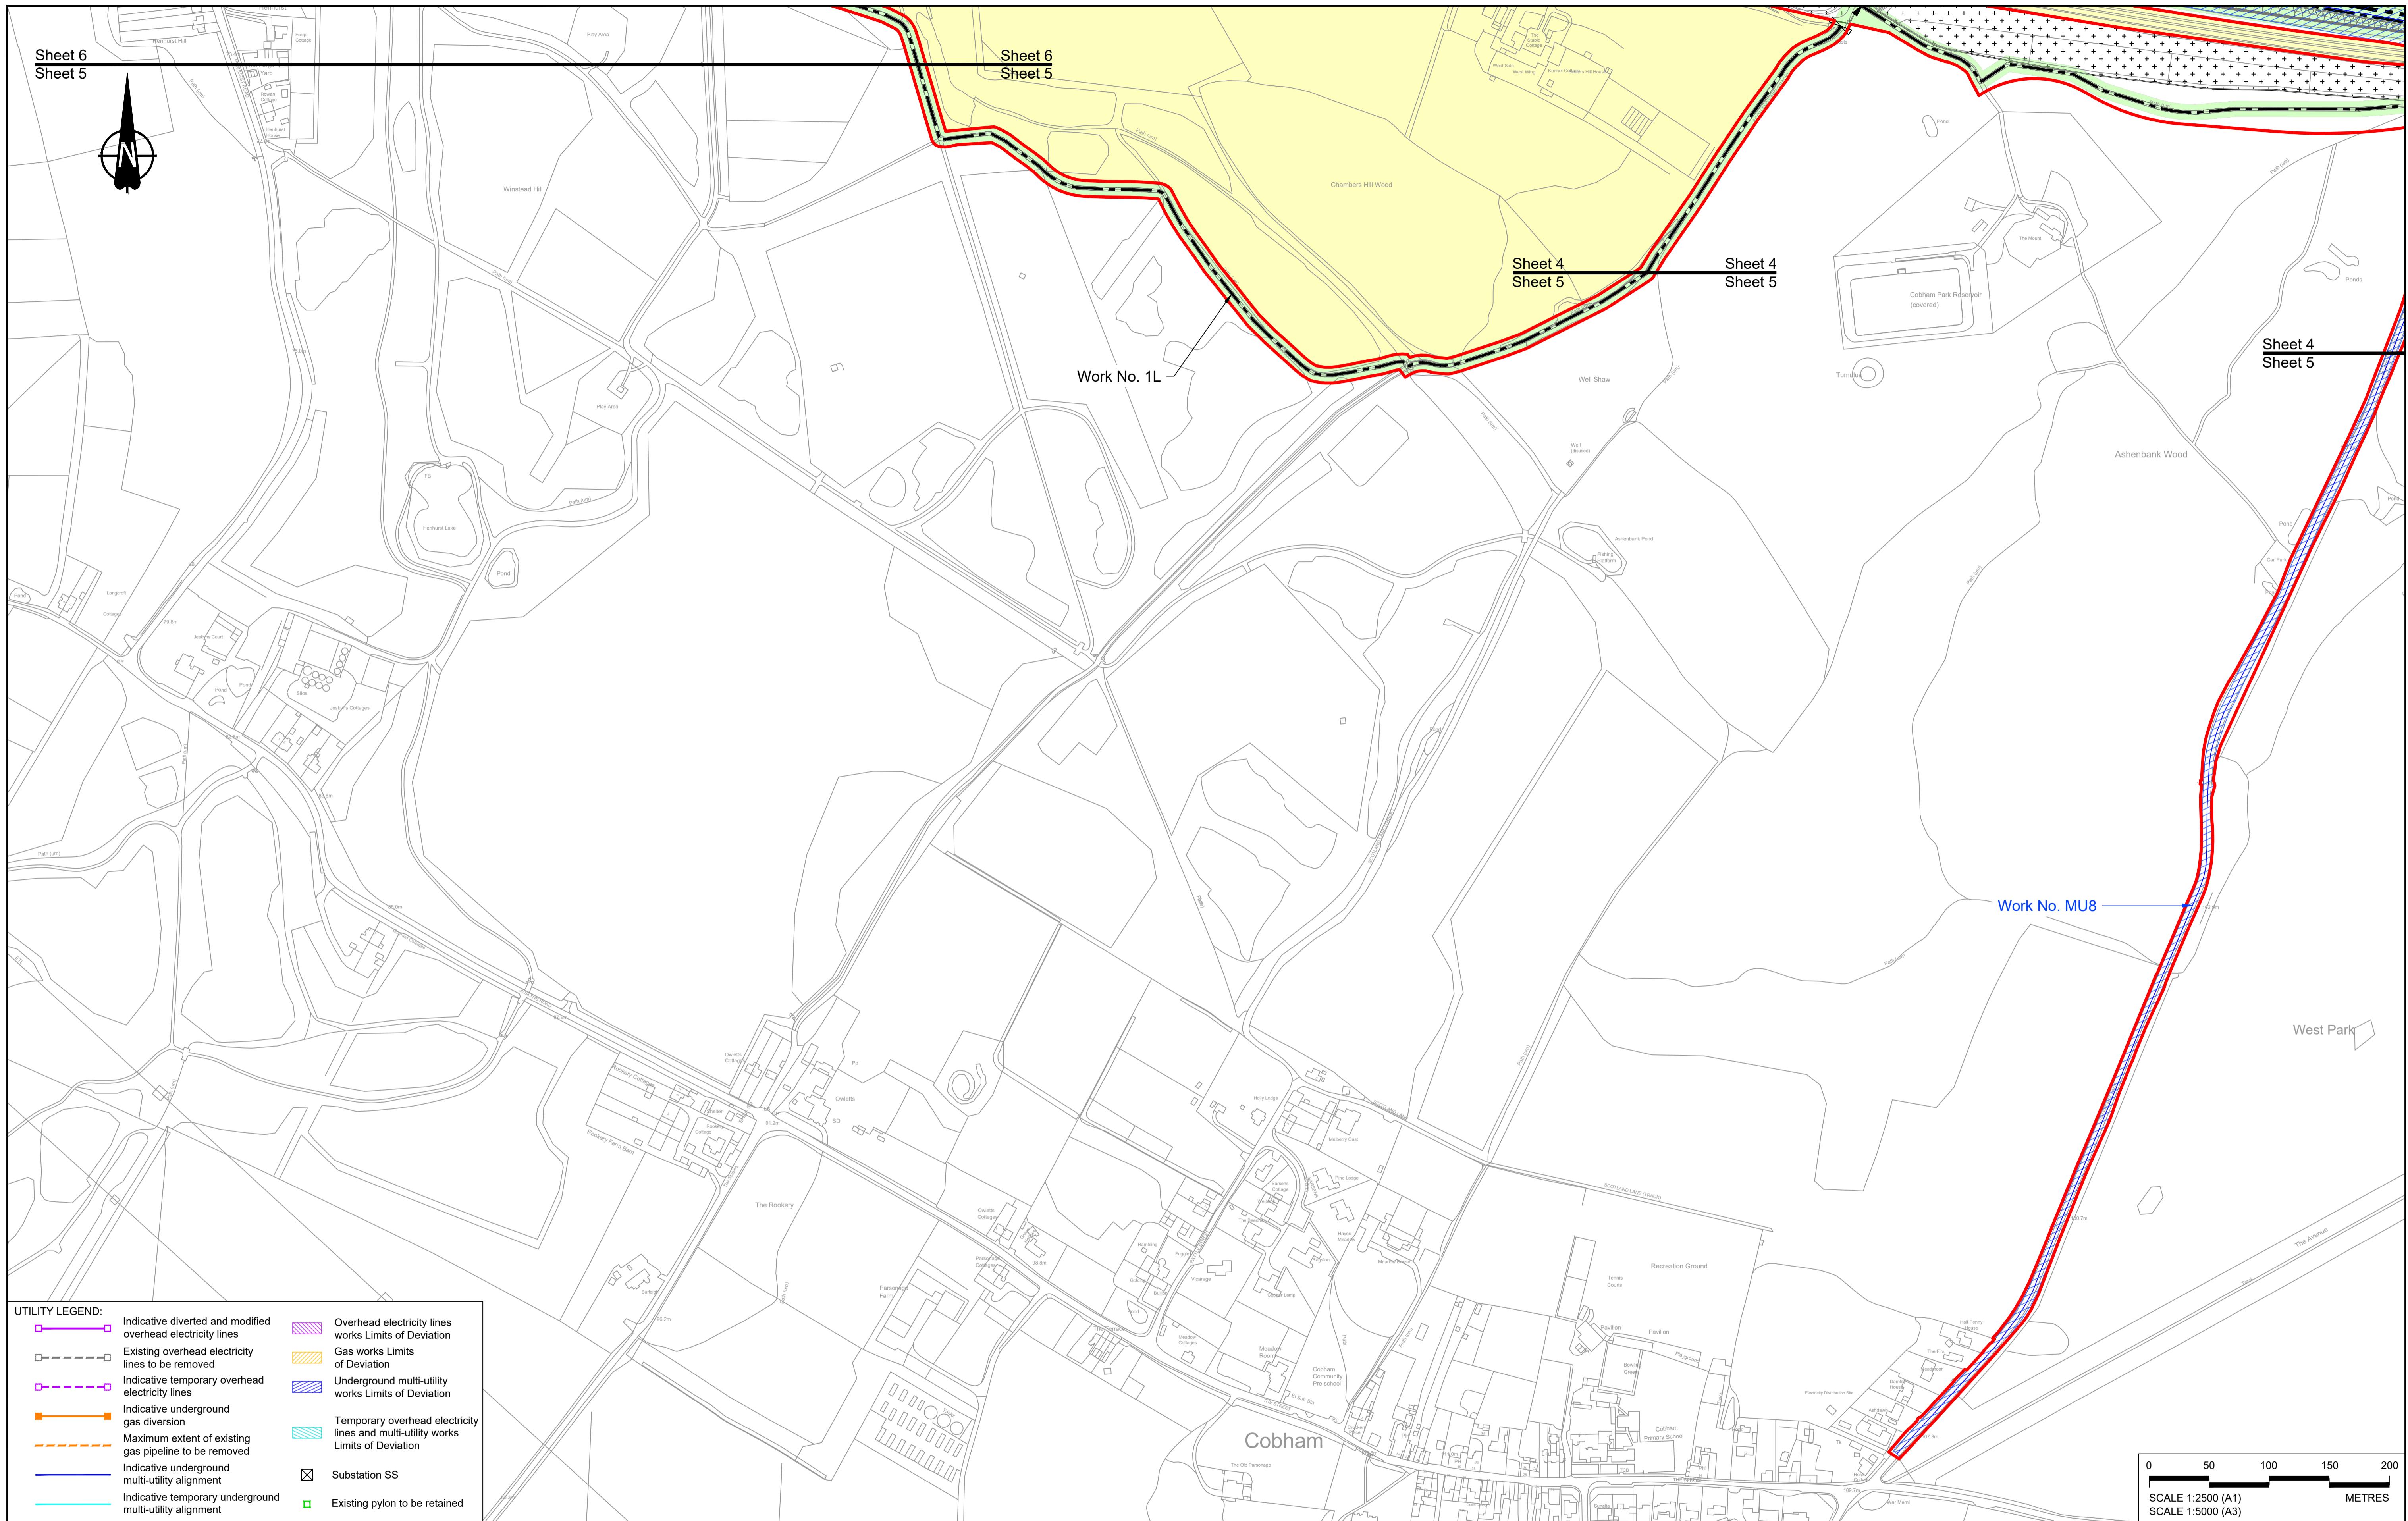

Contains Ordnance Survey data. © Crown copyright and database rights 2022. Ordnance Survey 100030649

- NOTES:**
- The proposed works shown are illustrative only and will be subject to change as part of detailed design development. Any changes will be limited to being within the constraints included in the Development Consent Order (application document reference TR010032/APP/3.1).
 - These plans should be read in conjunction with Schedule 1 (Authorised Development) of the Development Consent Order (application document reference TR010032/APP/3.1), the Land Plans (application document reference TR010032/APP/2.2) and the Engineering Drawings and Sections (application document reference TR010032/APP/2.9).
 - Proposed works are shown adjacent to the Order Limits to provide greater clarity of the extent of the work but could extend to the Order Limits as well.
 - The definition of streets is included in the Development Consent Order (application document reference TR010032/APP/3.1).


- LEGEND:**
- Order Limits
 - Linear Work Centreline (including streets)
 - Local Authority boundary
 - Highway Work (includes structures) Limits of Deviation
 - Area excluded from Order Limits
 - Flood compensation area
 - Culvert
 - Bridge/structure
 - Watercourse diversion work centreline
 - Infiltration basin, detention basin or retention pond boundary
 - Major structure
 - Commencement of linear work
 - Commencement and termination of linear work
 - Termination of linear work
 - Bat Barn structure
 - Construction Area - Utilities Logistic Hub
 - Construction Area - Main Works Compound
 - Ecological habitat creation and receptor site for protected species
 - Temporary ecological habitat
 - Open space provision, replacement open space or replacement common land
 - Travellers site
 - Water inlet with self-regulating valve

P01	S8	19/10/2022	DCO Application	MS	RO	ASB
P02	S8	11/12/2023	Deadline 9	MS	RO	ASB
Rev	Status	Rev. Date	Purpose of revision	Drawn	Chk'd	Apprv'd


- NOTES:**
- The proposed works shown are illustrative only and will be subject to change as part of detailed design development. Any changes will be limited to being within the constraints included in the Development Consent Order (application document reference TR010032/APP/3.1).
 - These plans should be read in conjunction with Schedule 1 (Authorised Development) of the Development Consent Order (application document reference TR010032/APP/3.1), the Land Plans (application document reference TR010032/APP/2.2) and the Engineering Drawings and Sections (application document reference TR010032/APP/2.9).
 - Proposed works are shown adjacent to the Order Limits to provide greater clarity of the extent of the work but could extend to the Order Limits as well.
 - The definition of streets is included in the Development Consent Order (application document reference TR010032/APP/3.1).

- LEGEND:**
- Order Limits
 - Linear Work Centreline (including streets)
 - Local Authority boundary
 - Highway Work (includes structures) Limits of Deviation
 - Area excluded from Order Limits
 - Flood compensation area
 - Culvert
 - Bridge/structure
 - Watercourse diversion work centreline
 - Infiltration basin, detention basin or retention pond boundary
 - Major structure
 - Commencement of linear work
 - Commencement and termination of linear work
 - Termination of linear work
 - Bat Barn structure
 - Construction Area - Utilities Logistic Hub
 - Construction Area - Main Works Compound
 - Ecological habitat creation and receptor site for protected species
 - Temporary ecological habitat
 - Open space provision, replacement open space or replacement common land
 - Travellers site
 - Water inlet with self-regulating valve

- LEGEND:**
- Order Limits
 - Linear Work Centreline (including streets)
 - Local Authority boundary
 - Highway Work (includes structures) Limits of Deviation
 - Area excluded from Order Limits
 - Flood compensation area
 - Culvert
 - Bridge/structure
 - Watercourse diversion work centreline
 - Infiltration basin, detention basin or retention pond boundary
 - Major structure
 - Commencement of linear work
 - Commencement and termination of linear work
 - Termination of linear work
 - Bat Barn structure
 - Construction Area - Utilities Logistic Hub
 - Construction Area - Main Works Compound
 - Ecological habitat creation and receptor site for protected species
 - Temporary ecological habitat
 - Open space provision, replacement open space or replacement common land
 - Travellers site
 - Water inlet with self-regulating valve

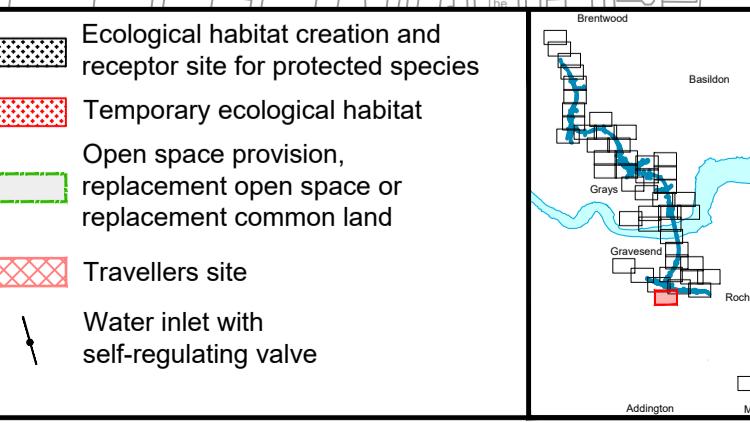

Client: national highways
Project: LOWER THAMES CROSSING
Status: DCO Examination
Original Size: A1
Revision: P02
Application Document Number: TR010032/APP/2.6
Scale: 1:2500
Drawing title: WORKS PLANS
REGULATION 5(2)(j)
SHEET 5 - COMPOSITE
Drawing Number: HE540039-CJV-BOP-SZZ_GN000000_DR-CX-20003

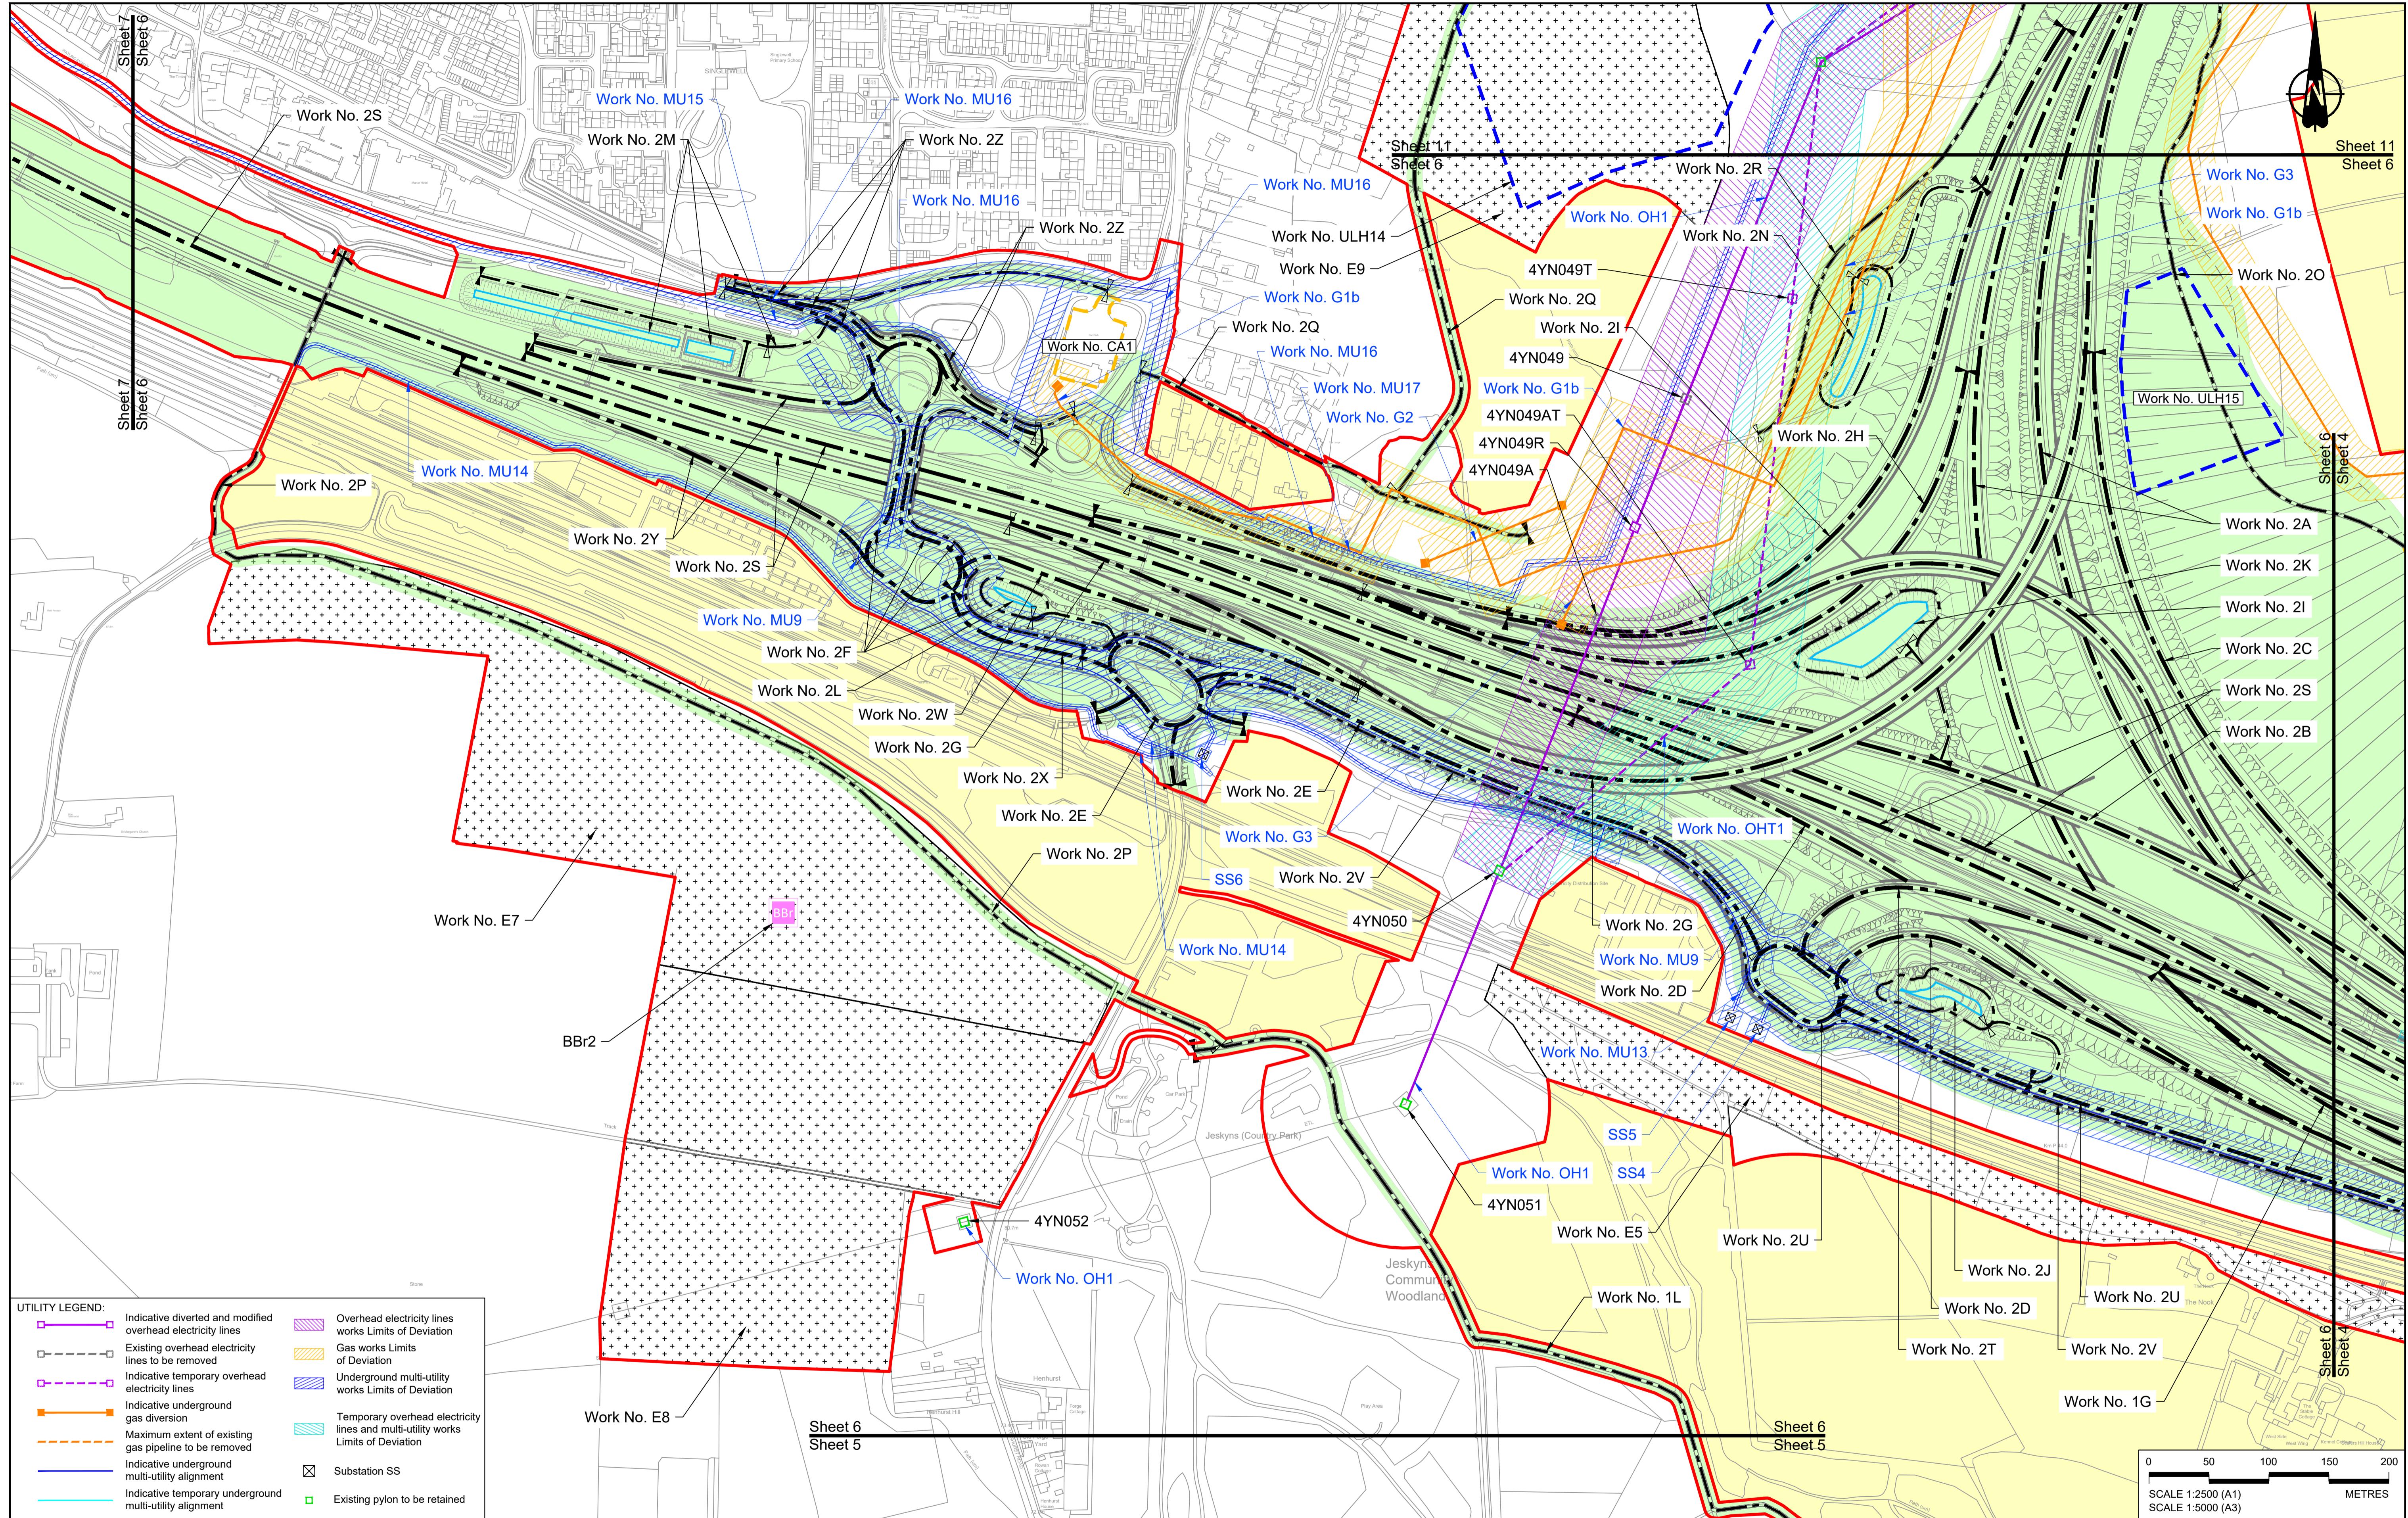


Contains Ordnance Survey data. © Crown copyright and database rights 2022. Ordnance Survey 100030649							
P01 S8 19/10/2022 DCO Application				MS	RO	ASB	
P02 S8 13/12/2022 Revision following SS1 advice				MS	RO	ASB	
P03 S8 24/08/2023 Deadline 3				MS	RO	ASB	
P04 S8 11/12/2023 Deadline 9				MS	RO	ASB	
Rev	Status	Rev. Date	Purpose of revision	Drawn	Chk'd	Apprv'd	

NOTES:


- The proposed works shown are illustrative only and will be subject to change as part of detailed design development. Any changes will be limited to being within the constraints included in the Development Consent Order (application document reference TR010032/APP3.1).
- These plans should be read in conjunction with Schedule 1 (Authorised Development) of the Development Consent Order (application document reference TR010032/APP3.1), the Land Plans (application document reference TR010032/APP2.2) and the Engineering Drawings and Sections (application document reference TR010032/APP2.9).
- Proposed works are shown adjacent to the Order Limits to provide greater clarity of the extent of the work but could extend to the Order Limits as well.
- The definition of streets is included in the Development Consent Order (application document reference TR010032/APP3.1).

LEGEND:

Order Limits	Flood compensation area	Commencement of linear work	Ecological habitat creation and receptor site for protected species
Linear Work Centreline (including streets)	Culvert	Termination of linear work	Temporary ecological habitat
Local Authority boundary	Bridge/structure	Watercourse diversion work centreline	Open space provision, replacement open space or replacement common land
Highway Work (includes structures) Limits of Deviation	Watercourse diversion work centreline	Infiltration basin, detention basin or retention pond boundary	Bat Barn structure
Area excluded from Order Limits	Infiltration basin, detention basin or retention pond boundary	Construction Area - Utilities Logistic Hub	Travellers site
	Major structure	Construction Area - Main Works Compound	Water inlet with self-regulating valve

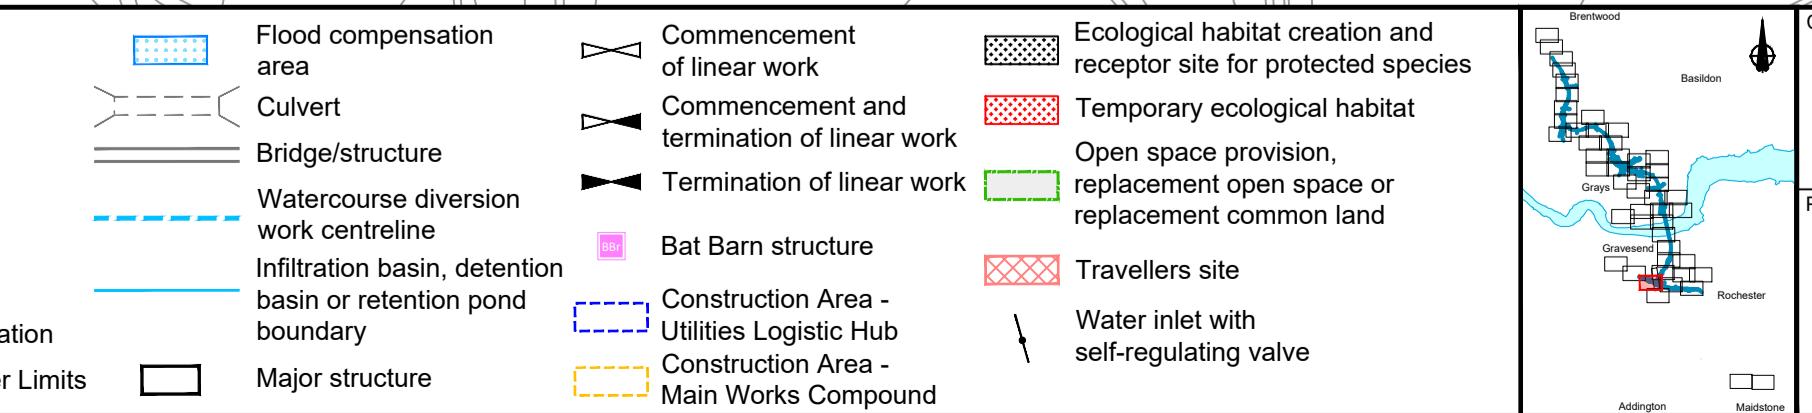

Client: national highways
Project: LOWER THAMES CROSSING
Status: DCO Examination
Original Size: A1
Revision: P04
Application Document Number: TR010032/APP/2.6
Scale: 1:2500
Drawing title: WORKS PLANS REGULATION 5(2)(j)
Project: LOWER THAMES CROSSING
Sheet 6 - Composite
Drawing Number: HE540039-CJV-BOP-SZZ_GN0000000_DR-CX-20004

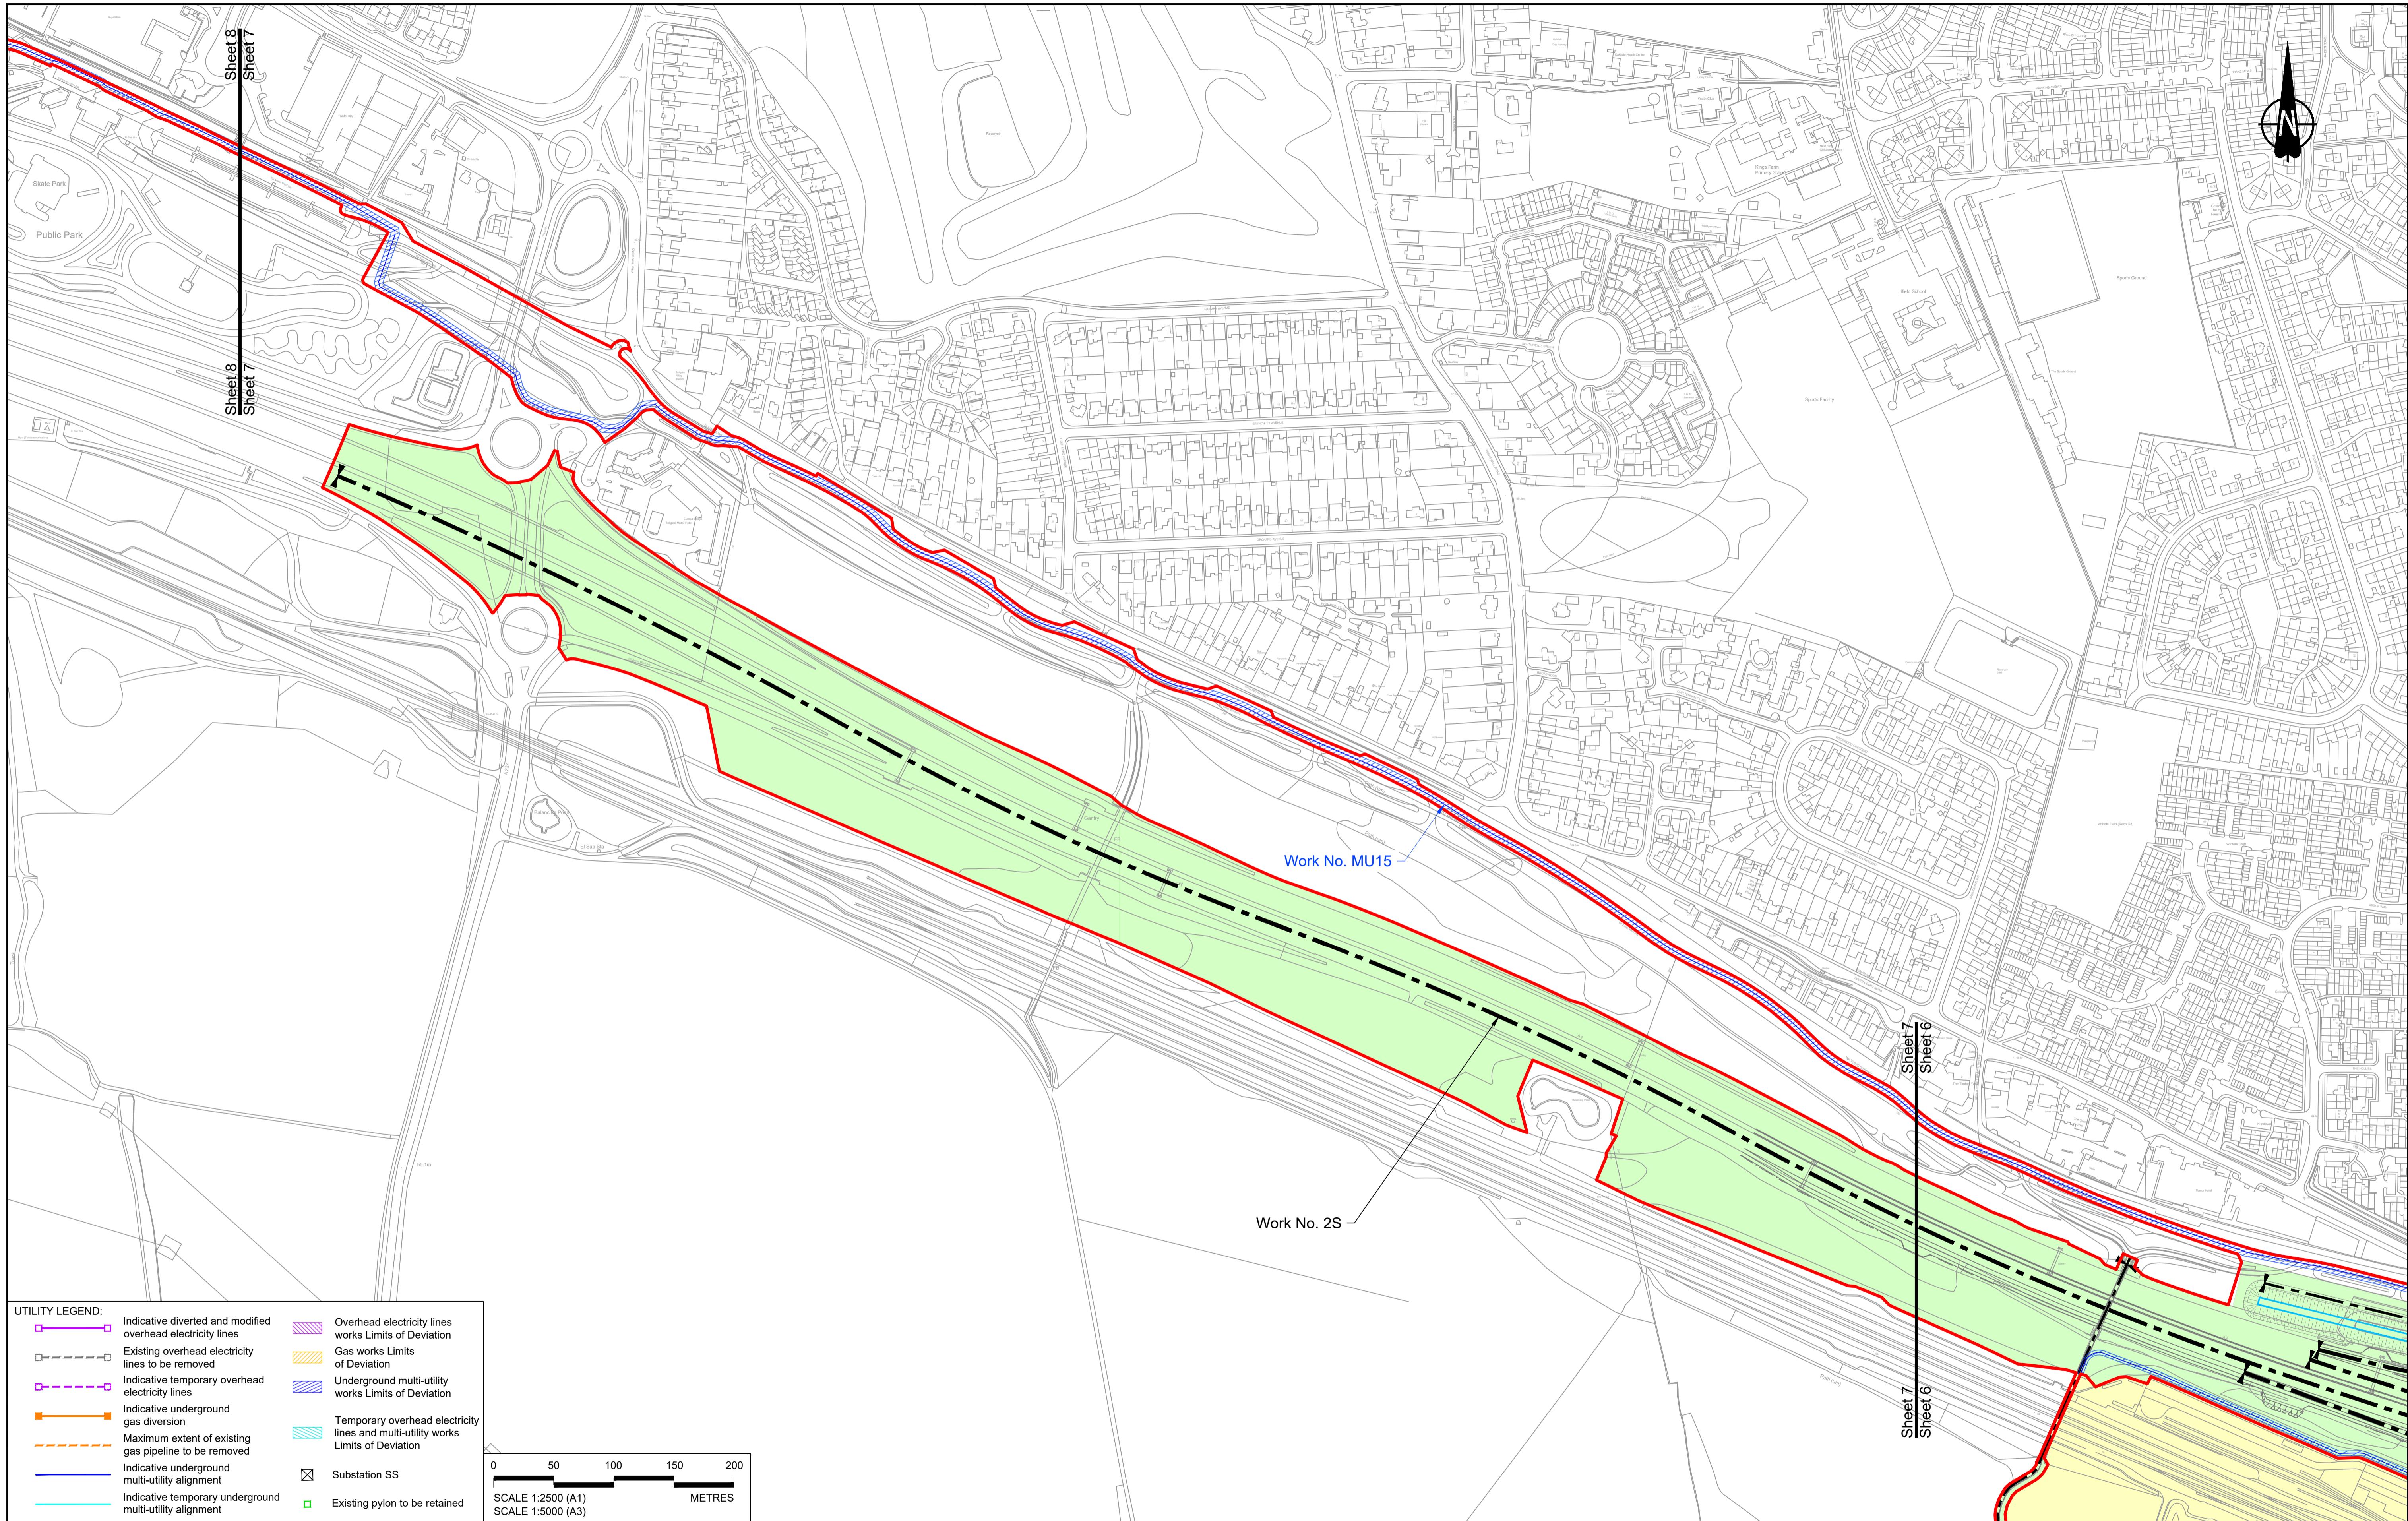

Contains Ordnance Survey data. © Crown copyright and database rights 2022. Ordnance Survey 100030649


P01	S8	19/10/2022	DCO Application	MS	RO	ASB
P02	S8	11/12/2023	Deadline 9	MS	RO	ASB
Rev	Status	Rev. Date	Purpose of revision	Drawn	Chk'd	Apprv'd

NOTES:

- The proposed works shown are illustrative only and will be subject to change as part of detailed design development. Any changes will be limited to being within the constraints included in the Development Consent Order (application document reference TR010032/APP/3.1).
- These plans should be read in conjunction with Schedule 1 (Authorised Development) of the Development Consent Order (application document reference TR010032/APP/3.1), the Land Plans (application document reference TR010032/APP/2.2) and the Engineering Drawings and Sections (application document reference TR010032/APP/2.9).
- Proposed works are shown adjacent to the Order Limits to provide greater clarity of the extent of the work but could extend to the Order Limits as well.
- The definition of streets is included in the Development Consent Order (application document reference TR010032/APP/3.1).


LEGEND:


- Order Limits
- Linear Work Centreline (including streets)
- Local Authority boundary
- Highway Work (includes structures) Limits of Deviation
- Flood compensation area
- Culvert
- Bridge/structure
- Watercourse diversion work centreline
- Infiltration basin, detention basin or retention pond boundary
- Major structure
- Commencement of linear work
- Commencement and termination of linear work
- Termination of linear work
- Bat Barn structure
- Construction Area - Utilities Logistic Hub
- Construction Area - Main Works Compound
- Ecological habitat creation and receptor site for protected species
- Temporary ecological habitat
- Open space provision, replacement open space or replacement common land
- Travellers site
- Water inlet with self-regulating valve

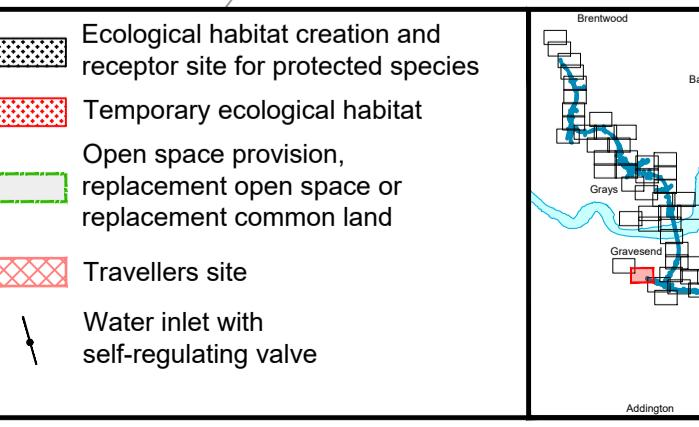

Client: national highways
Project: LOWER THAMES CROSSING
Status: DCO Examination
Application Document Number: TR010032/APP/2.6
Scale: 1:2500
Drawing title: WORKS PLANS
REGULATION 5(2)(j)
SHEET 7 - COMPOSITE
Drawing Number: HE540039-CJV-BOP-SZZ_GN000000_DR-CX-20005


HE540039-CJV-BOP-SZZ_GN000000_DR-CX-20005.dwg

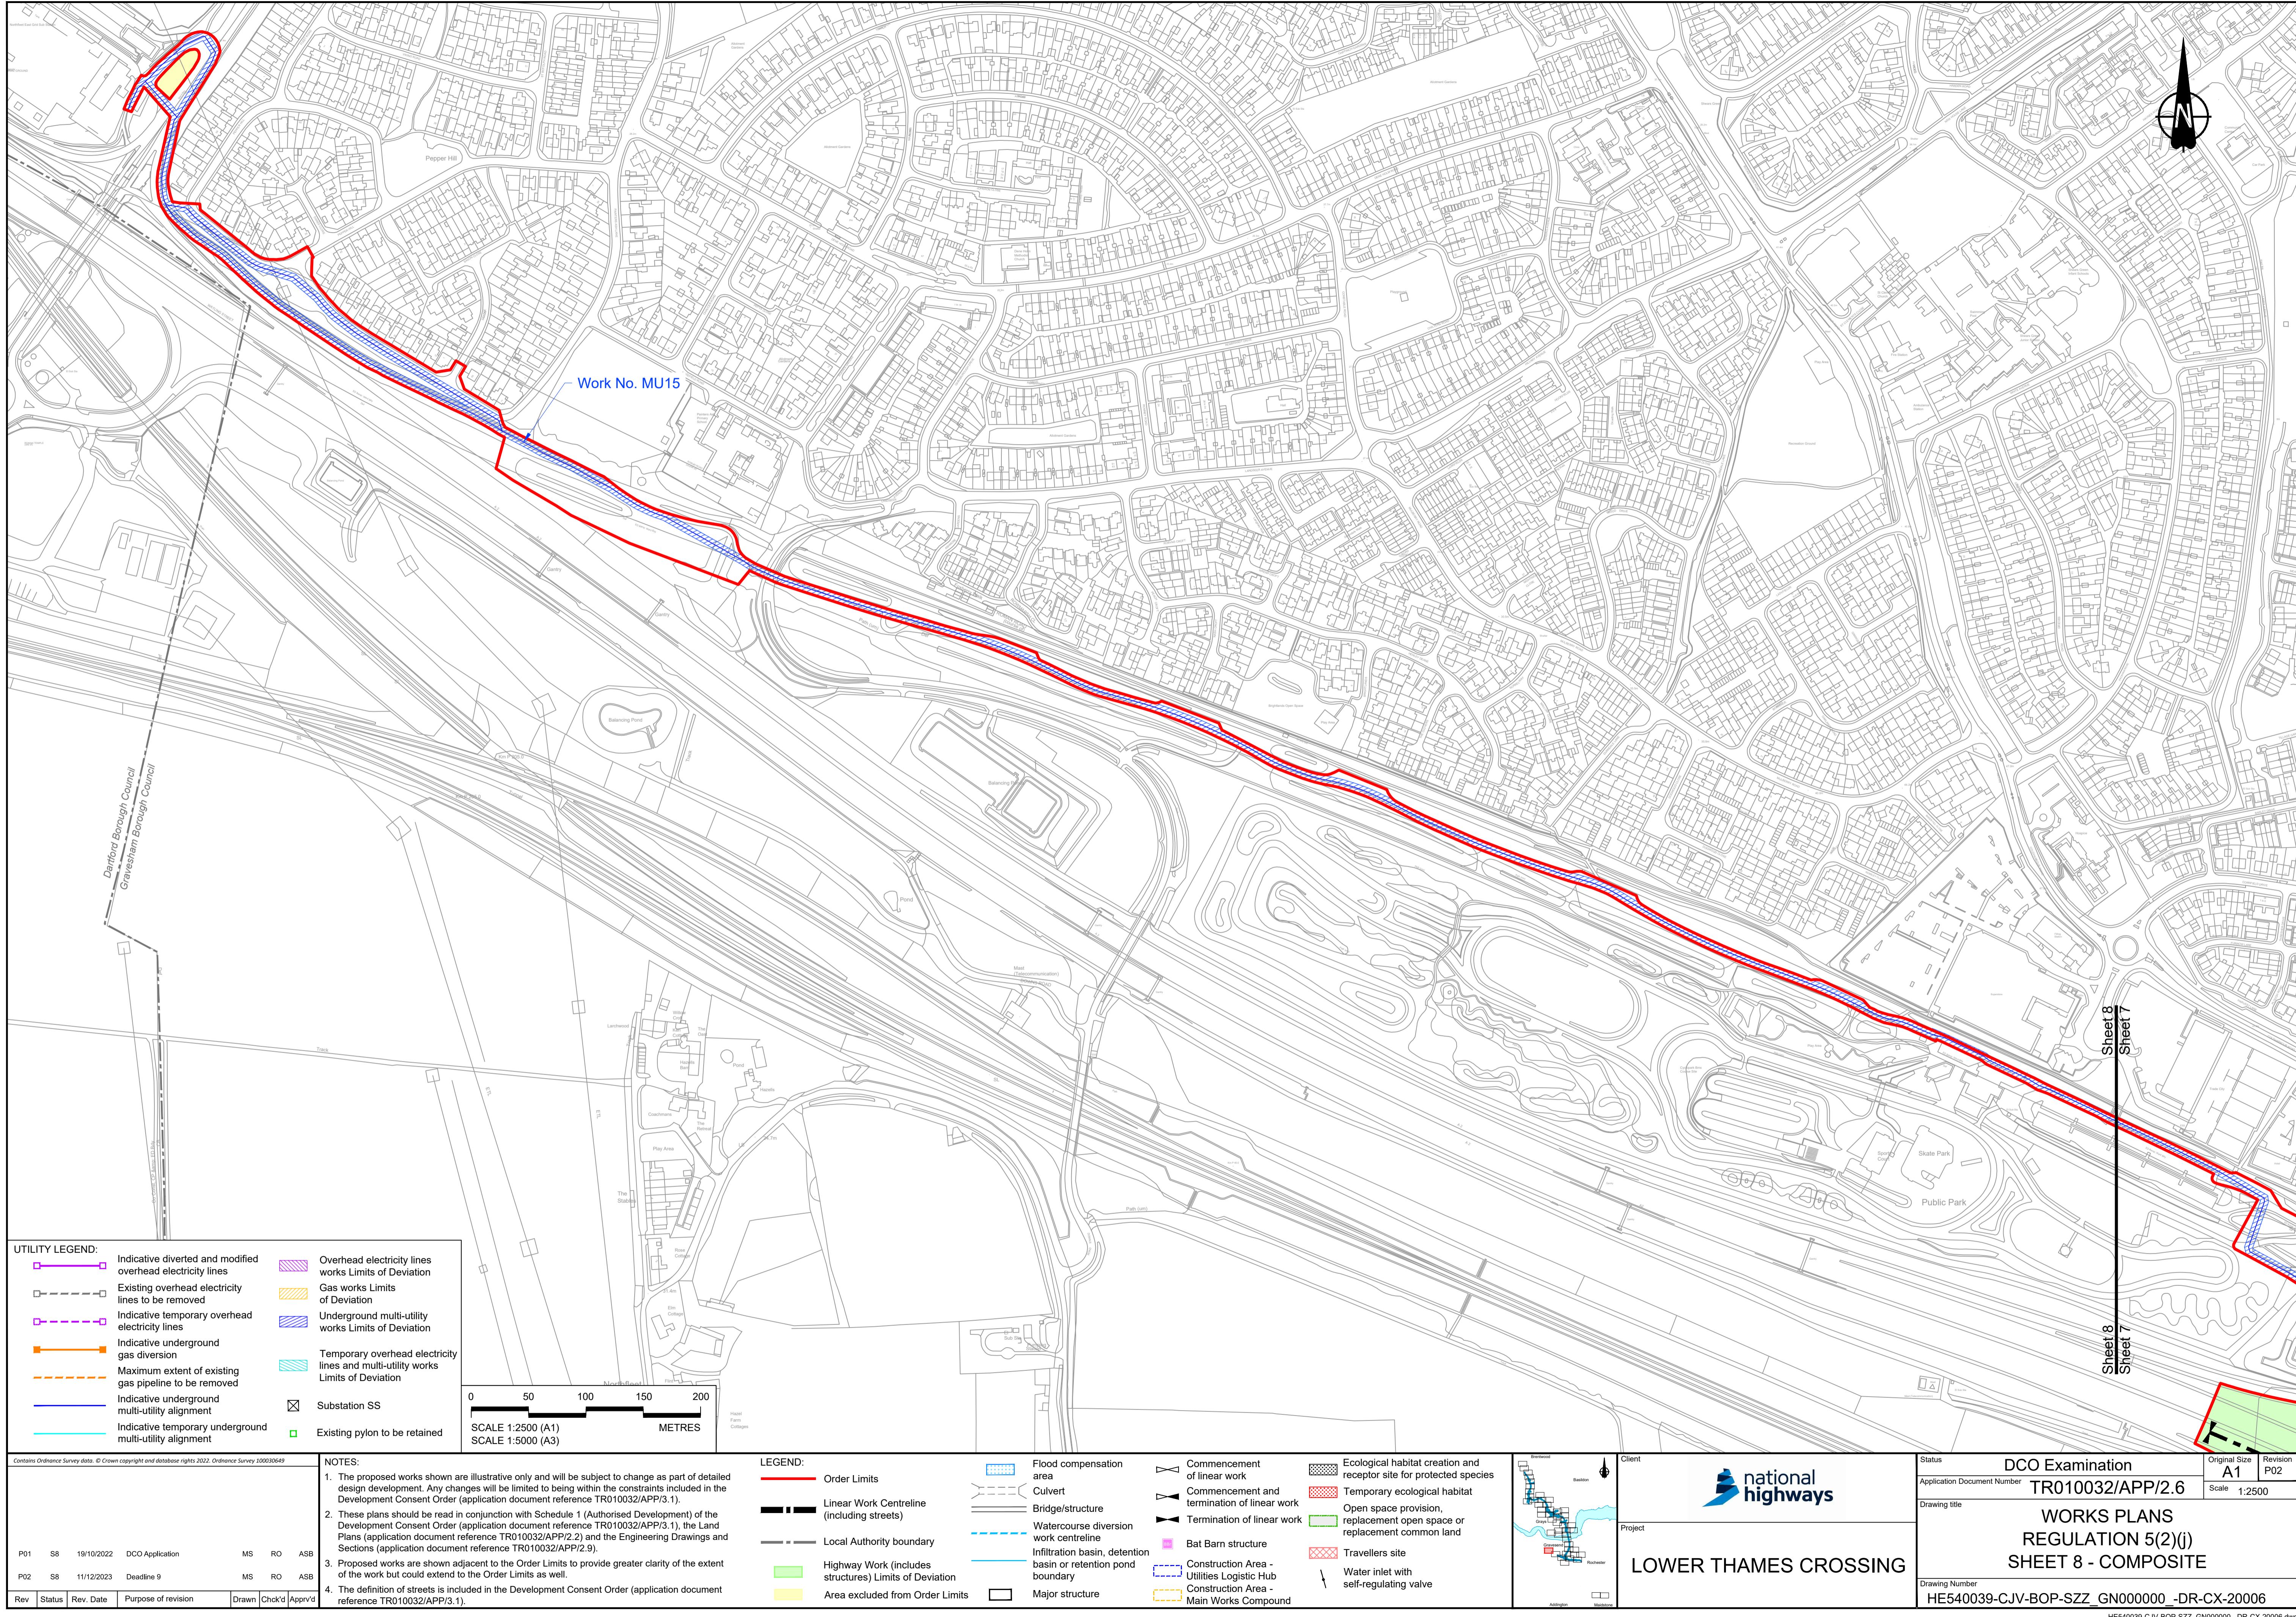

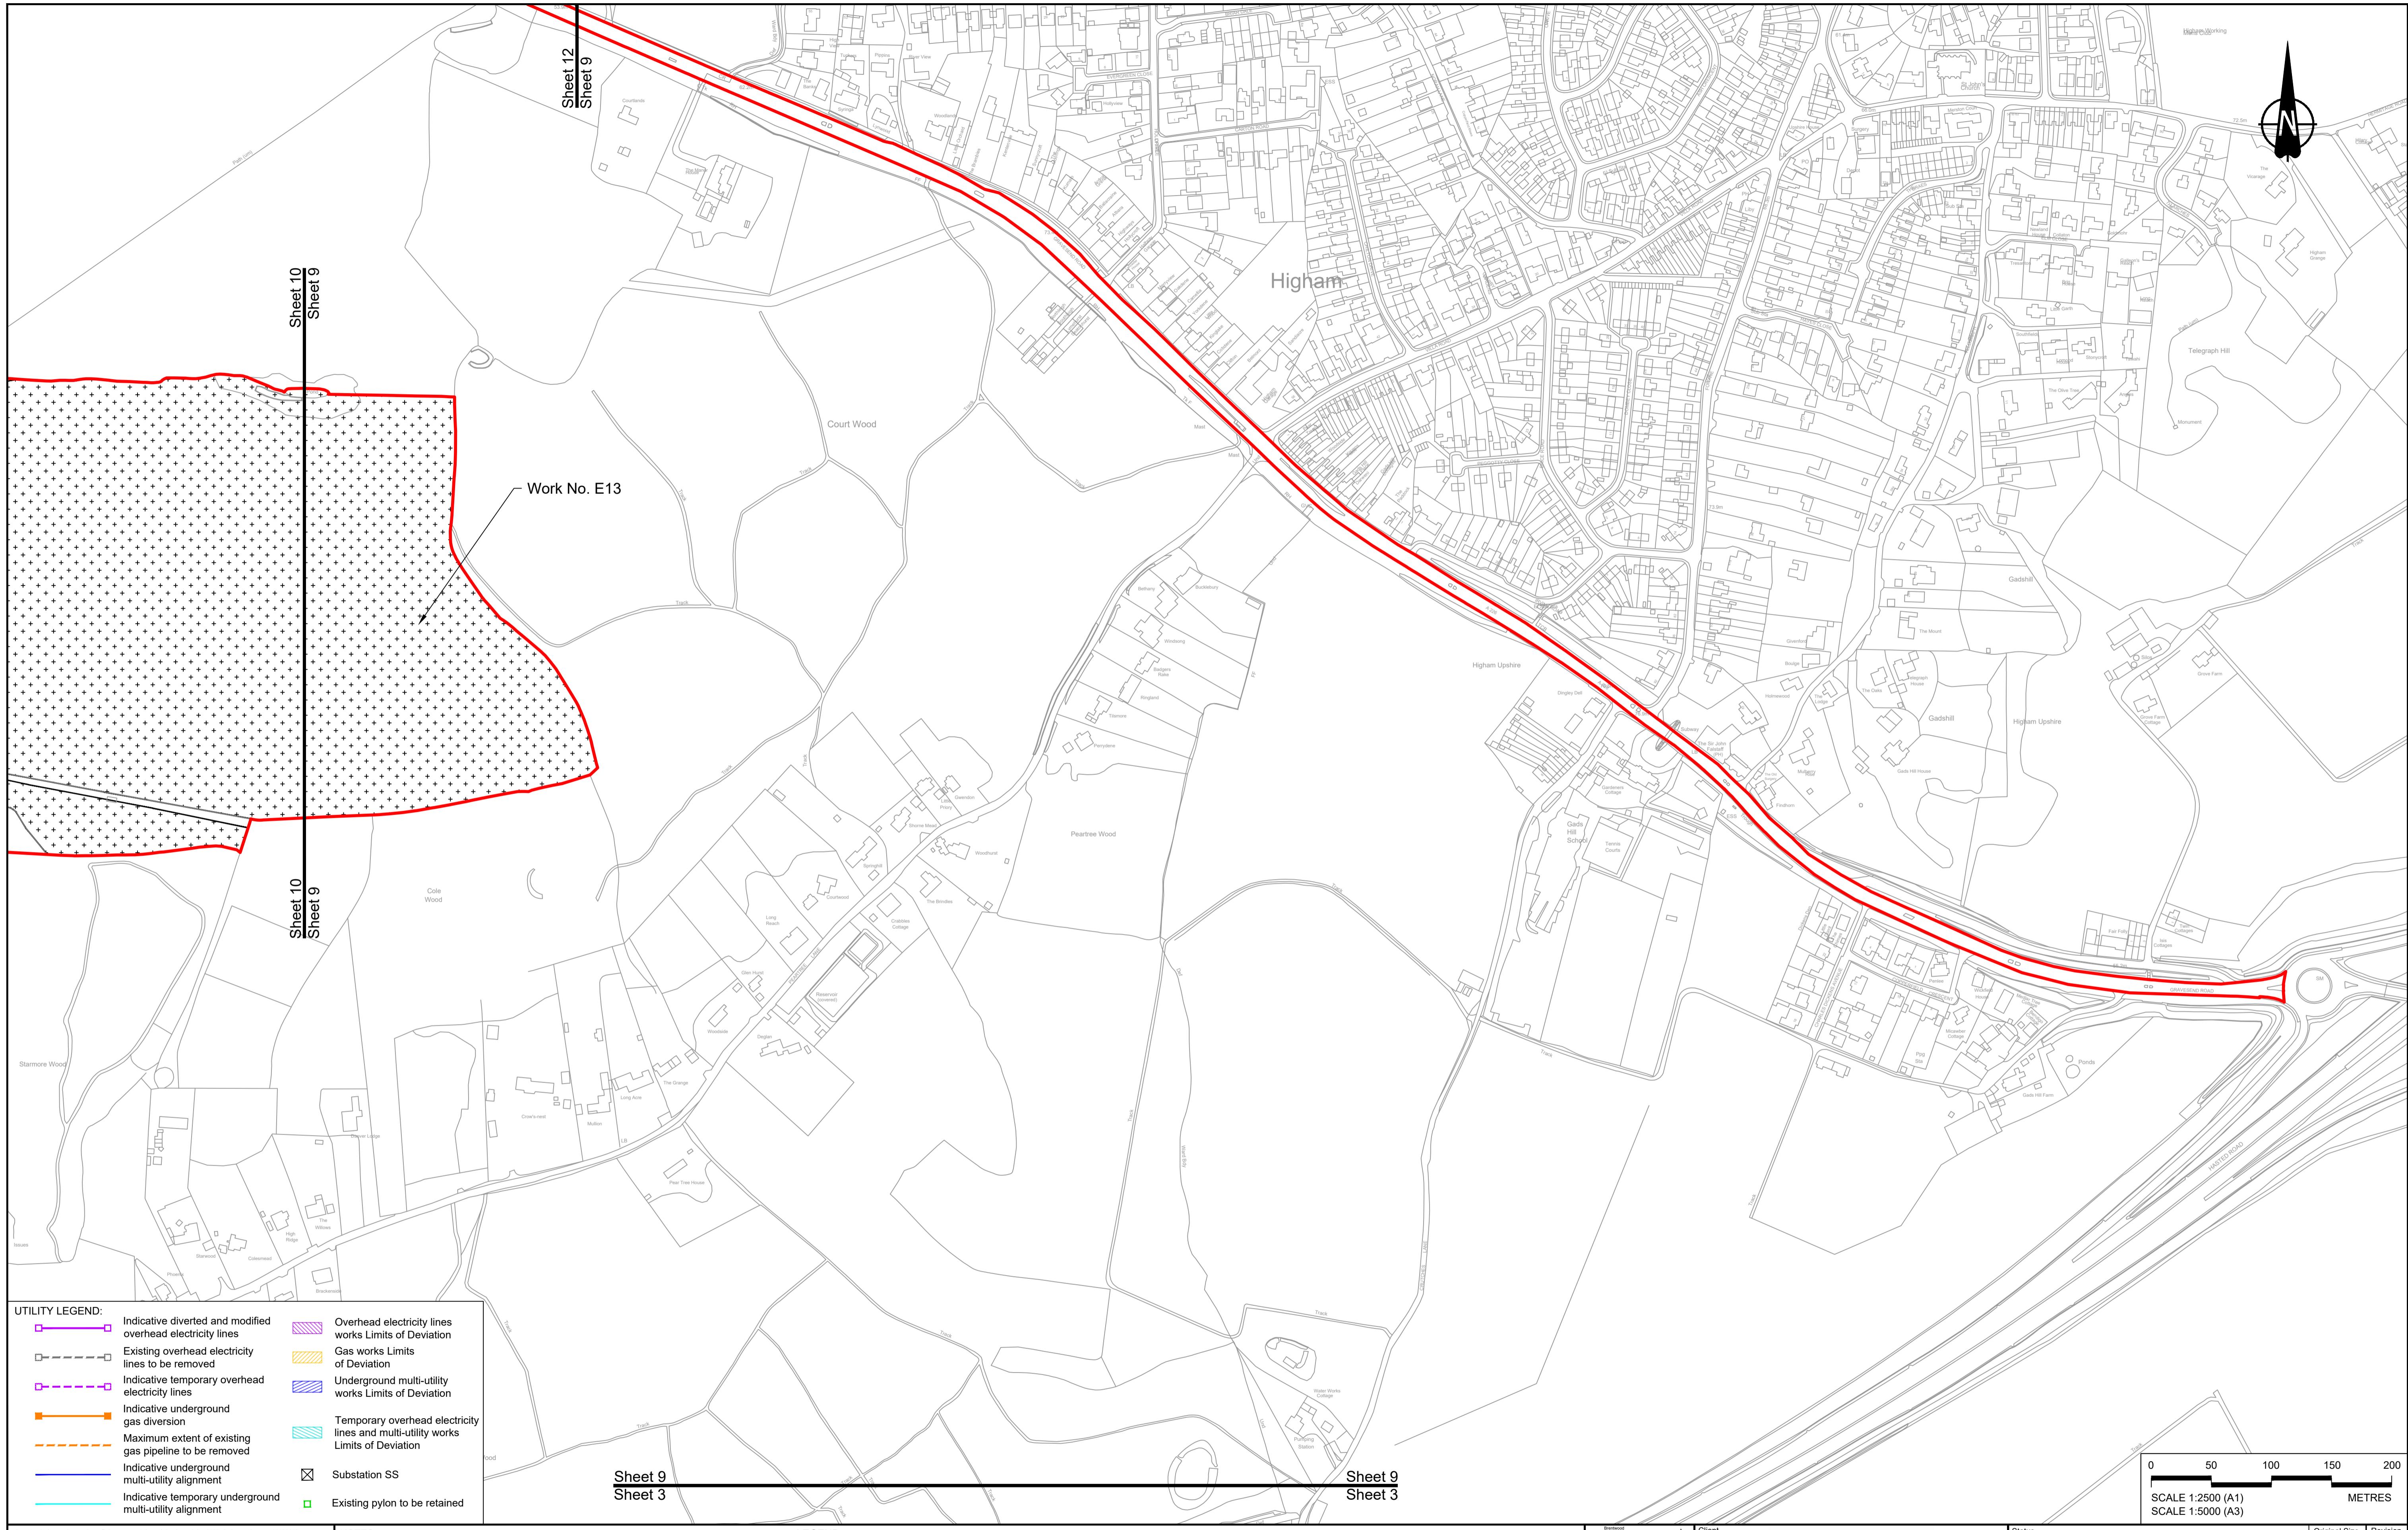


Contains Ordnance Survey data. © Crown copyright and database rights 2022. Ordnance Survey 100030649											
NOTES:											
P01	S8	19/10/2022	DCO Application	MS	RO	ASB					
P02	S8	11/12/2023	Deadline 9	MS	RO	ASB					
Rev	Status	Rev. Date	Purpose of revision	Drawn	Chk'd	Apprv'd					

LEGEND:
Order Limits
Linear Work Centreline (including streets)
Local Authority boundary
Highway Work (includes structures) Limits of Deviation
Flood compensation area
Culvert
Bridge/structure
Watercourse diversion work centreline
Infiltration basin, detention basin or retention pond boundary
Area excluded from Order Limits
Commencement of linear work
Commencement and termination of linear work
Termination of linear work
Bat Barn structure
Construction Area - Utilities Logistic Hub
Construction Area - Main Works Compound
Ecological habitat creation and receptor site for protected species
Temporary ecological habitat
Open space provision, replacement open space or replacement common land
Travellers site
Water inlet with self-regulating valve
Major structure

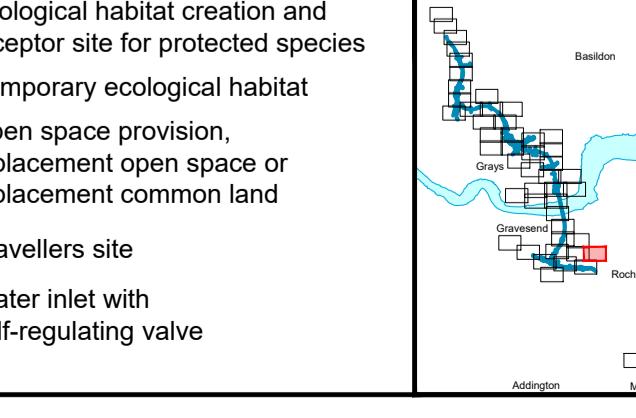




Client: national highways
Project: LOWER THAMES CROSSING
Drawing Number: HE540039-CJV-BOP-SZZ_GN000000_DR-CX-2007

Status	DCO Examination	Original Size A1	Revision P02			
Application Document Number	TR010032/APP/2.6	Scale	1:2500			
Drawing title	WORKS PLANS REGULATION 5(2)(j) SHEET 9 - COMPOSITE					

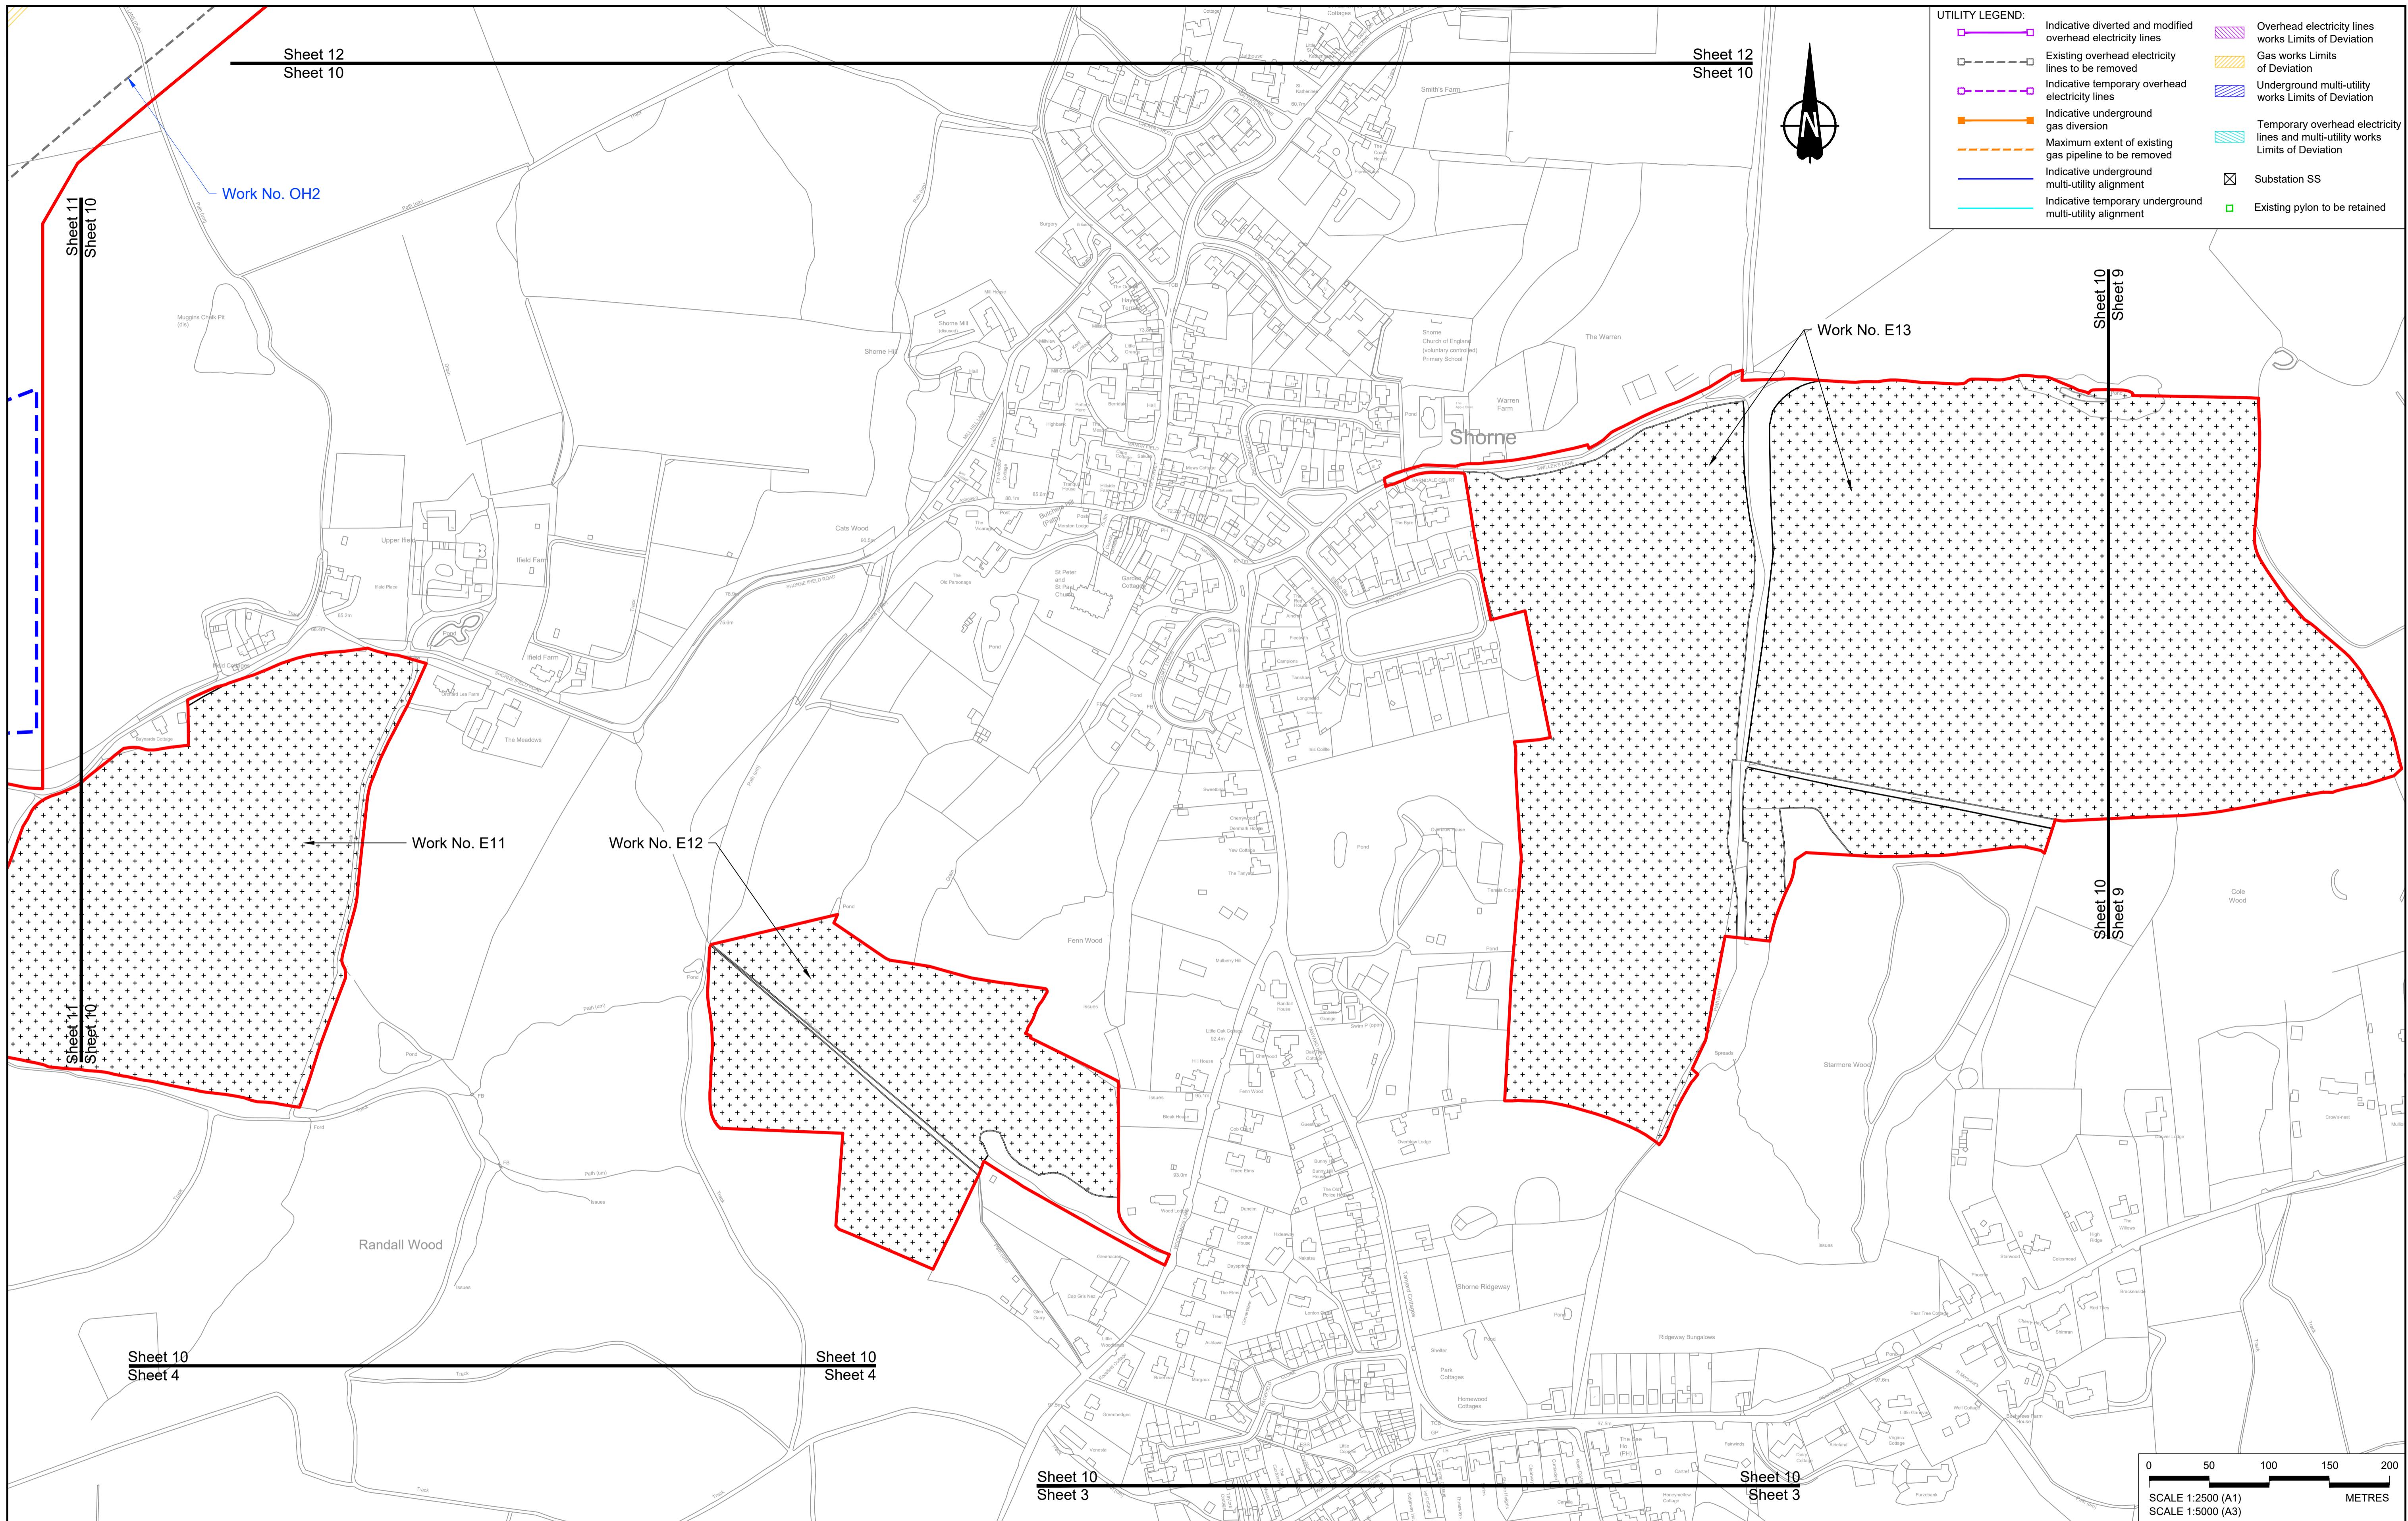

Contains Ordnance Survey data. © Crown copyright and database rights 2022. Ordnance Survey 100030649											
NOTES:											
P01	S8	19/10/2022	DCO Application	MS	RO	ASB					
P02	S8	11/12/2023	Deadline 9	MS	RO	ASB					
Rev	Status	Rev. Date	Purpose of revision	Drawn	Chkd	Apprv'd					

- LEGEND:
- Order Limits
 - Linear Work Centreline (including streets)
 - Local Authority boundary
 - Highway Work (includes structures) Limits of Deviation
 - Area excluded from Order Limits
- The proposed works shown are illustrative only and will be subject to change as part of detailed design development. Any changes will be limited to being within the constraints included in the Development Consent Order (application document reference TR010032/APP/3.1).
 - These plans should be read in conjunction with Schedule 1 (Authorised Development) of the Development Consent Order (application document reference TR010032/APP/3.1), the Land Plans (application document reference TR010032/APP/2.2) and the Engineering Drawings and Sections (application document reference TR010032/APP/2.9).
 - Proposed works are shown adjacent to the Order Limits to provide greater clarity of the extent of the work but could extend to the Order Limits as well.
 - The definition of streets is included in the Development Consent Order (application document reference TR010032/APP/3.1).

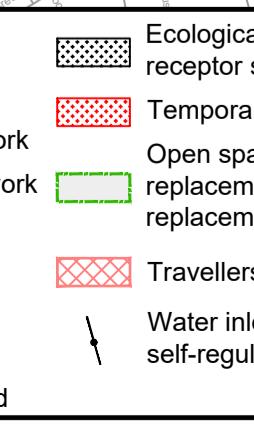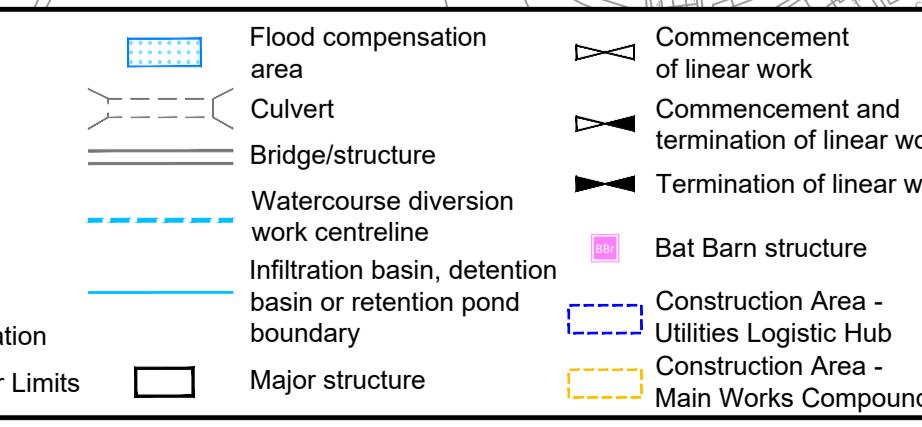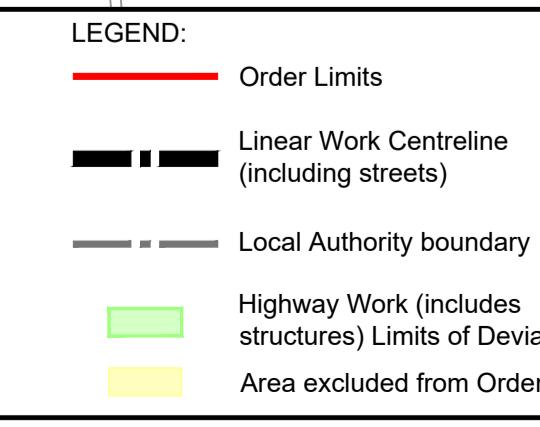

Client

Project

Status

DCO Examination

Original Size

Revision

A1

P02

Application Document Number

TR010032/APP/2.6

Scale


1:2500

Drawing title

WORKS PLANS
REGULATION 5(2)(j)
SHEET 10 - COMPOSITE

Drawing Number

HE540039-CJV-BOP-SZZ_GN0000000_DR-CX-20008.dwg

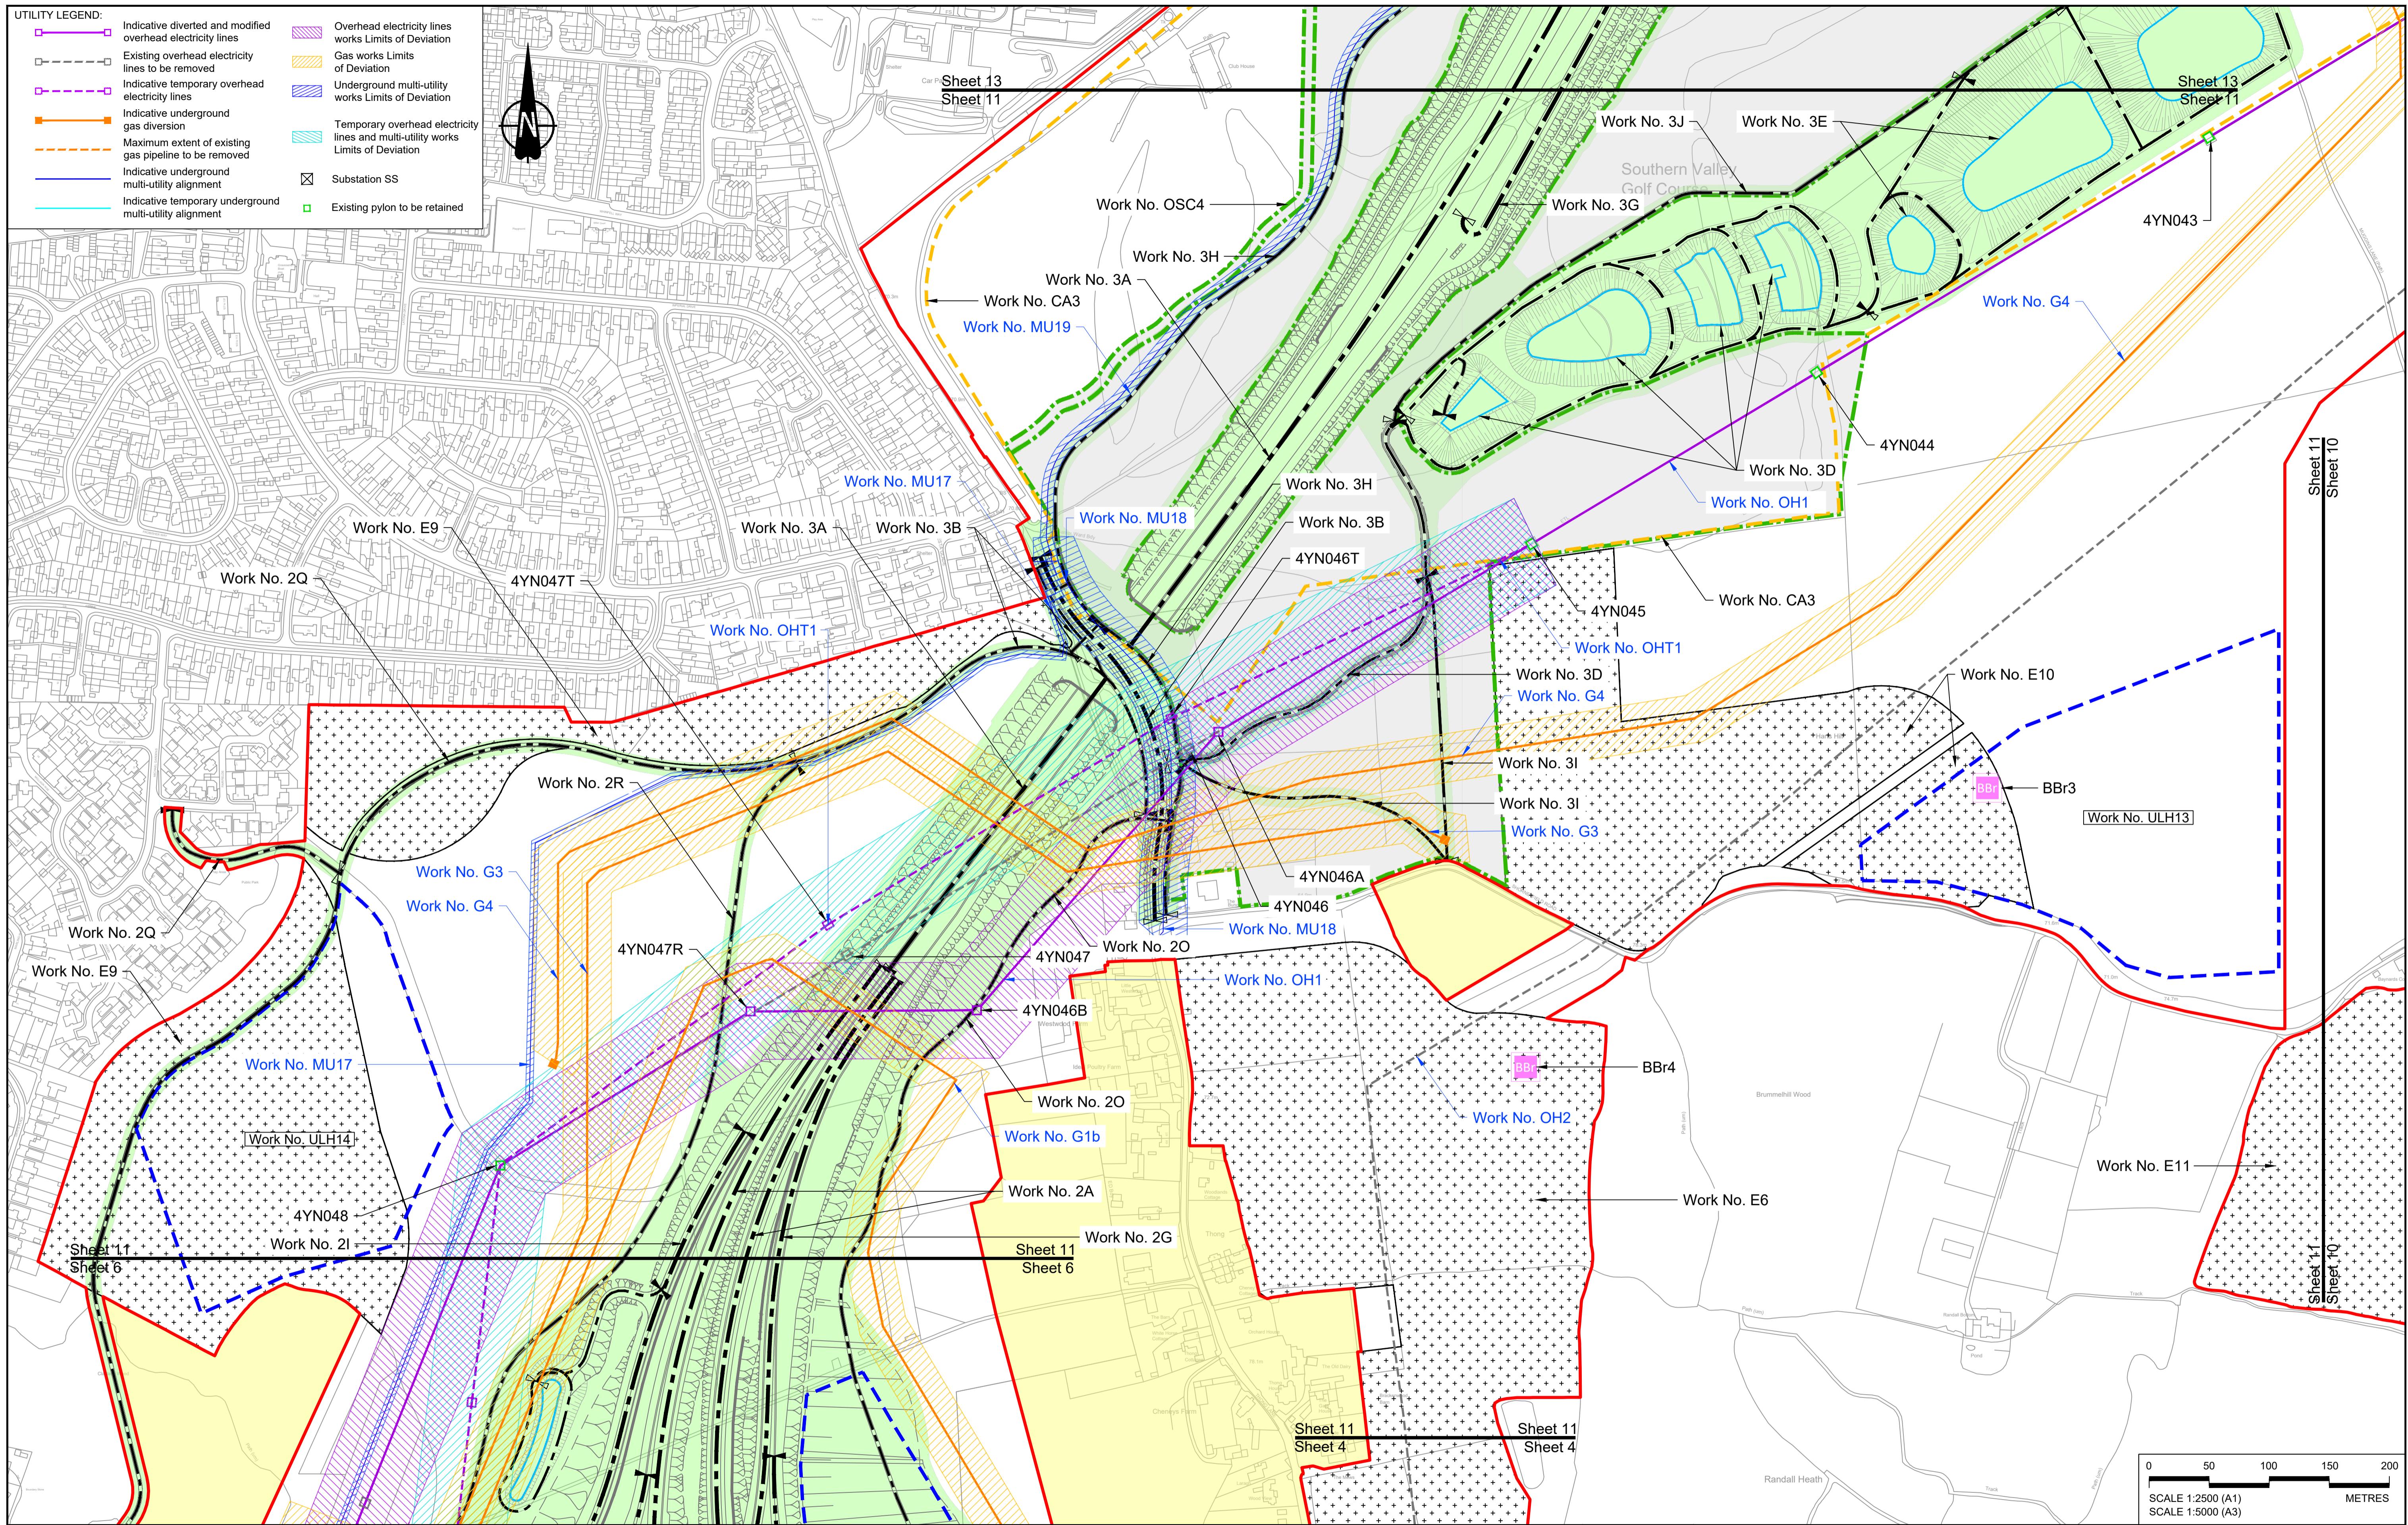


Contains Ordnance Survey data. © Crown copyright and database rights 2022. Ordnance Survey 100030649											
P01 S8 19/10/2022 DCO Application MS RO ASB											
P02 S8 13/12/2022 Revision following S51 advice MS RO ASB											
P03 S8 24/08/2023 Deadline 3 MS RO ASB											
P04 S8 17/11/2023 Deadline 7 MS RO ASB											
P05 S8 11/12/2023 Deadline 9 MS RO ASB											
Rev	Status	Rev. Date	Purpose of revision	Drawn	Chk'd	Apprv'd					


NOTES:

- The proposed works shown are illustrative only and will be subject to change as part of detailed design development. Any changes will be limited to being within the constraints included in the Development Consent Order (application document reference TR010032/APP/3.1).
- These plans should be read in conjunction with Schedule 1 (Authorised Development) of the Development Consent Order (application document reference TR010032/APP/2.1), the Land Plans (application document reference TR010032/APP/2.2) and the Engineering Drawings and Sections (application document reference TR010032/APP/2.9).
- Proposed works are shown adjacent to the Order Limits to provide greater clarity of the extent of the work but could extend to the Order Limits as well.
- The definition of streets is included in the Development Consent Order (application document reference TR010032/APP/3.1).

LEGEND:	Flood compensation area	Commencement of linear work	Ecological habitat creation and receptor site for protected species
Order Limits	Culvert	Commencement and termination of linear work	Temporary ecological habitat
Linear Work Centreline (including streets)	Bridge/structure	Termination of linear work	Open space provision, replacement open space or replacement common land
Local Authority boundary	Watercourse diversion work centreline	Infiltration basin, detention basin or retention pond boundary	Bat Barn structure
Highway Work (includes structures) Limits of Deviation	Major structure	Construction Area - Utilities Logistic Hub	Travellers site
Area excluded from Order Limits		Construction Area - Main Works Compound	Water inlet with self-regulating valve

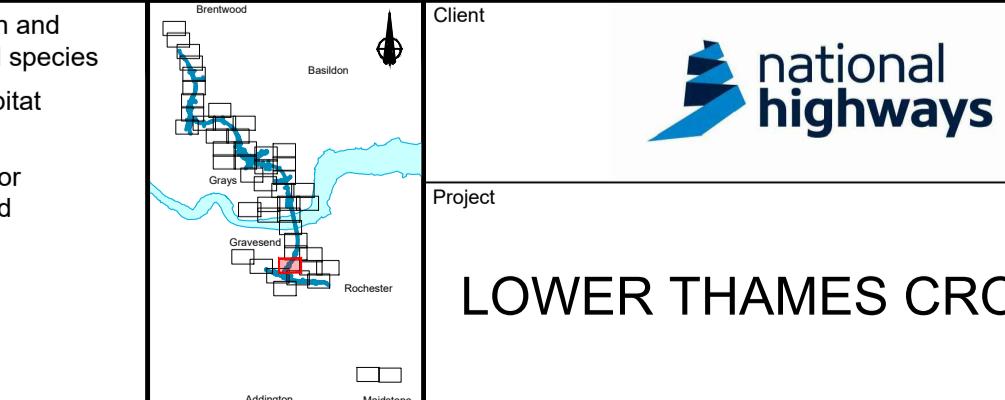

Status	DCO Examination	Original Size A1	Revision P05
Application Document Number	TR010032/APP/2.6	Scale 1:2500	
Drawing title	WORKS PLANS		
	REGULATION 5(2)(j)		
	SHEET 11 - COMPOSITE		
Drawing Number	HE540039-CJV-BOP-SZZ_GN000000_DR-CX-20009		

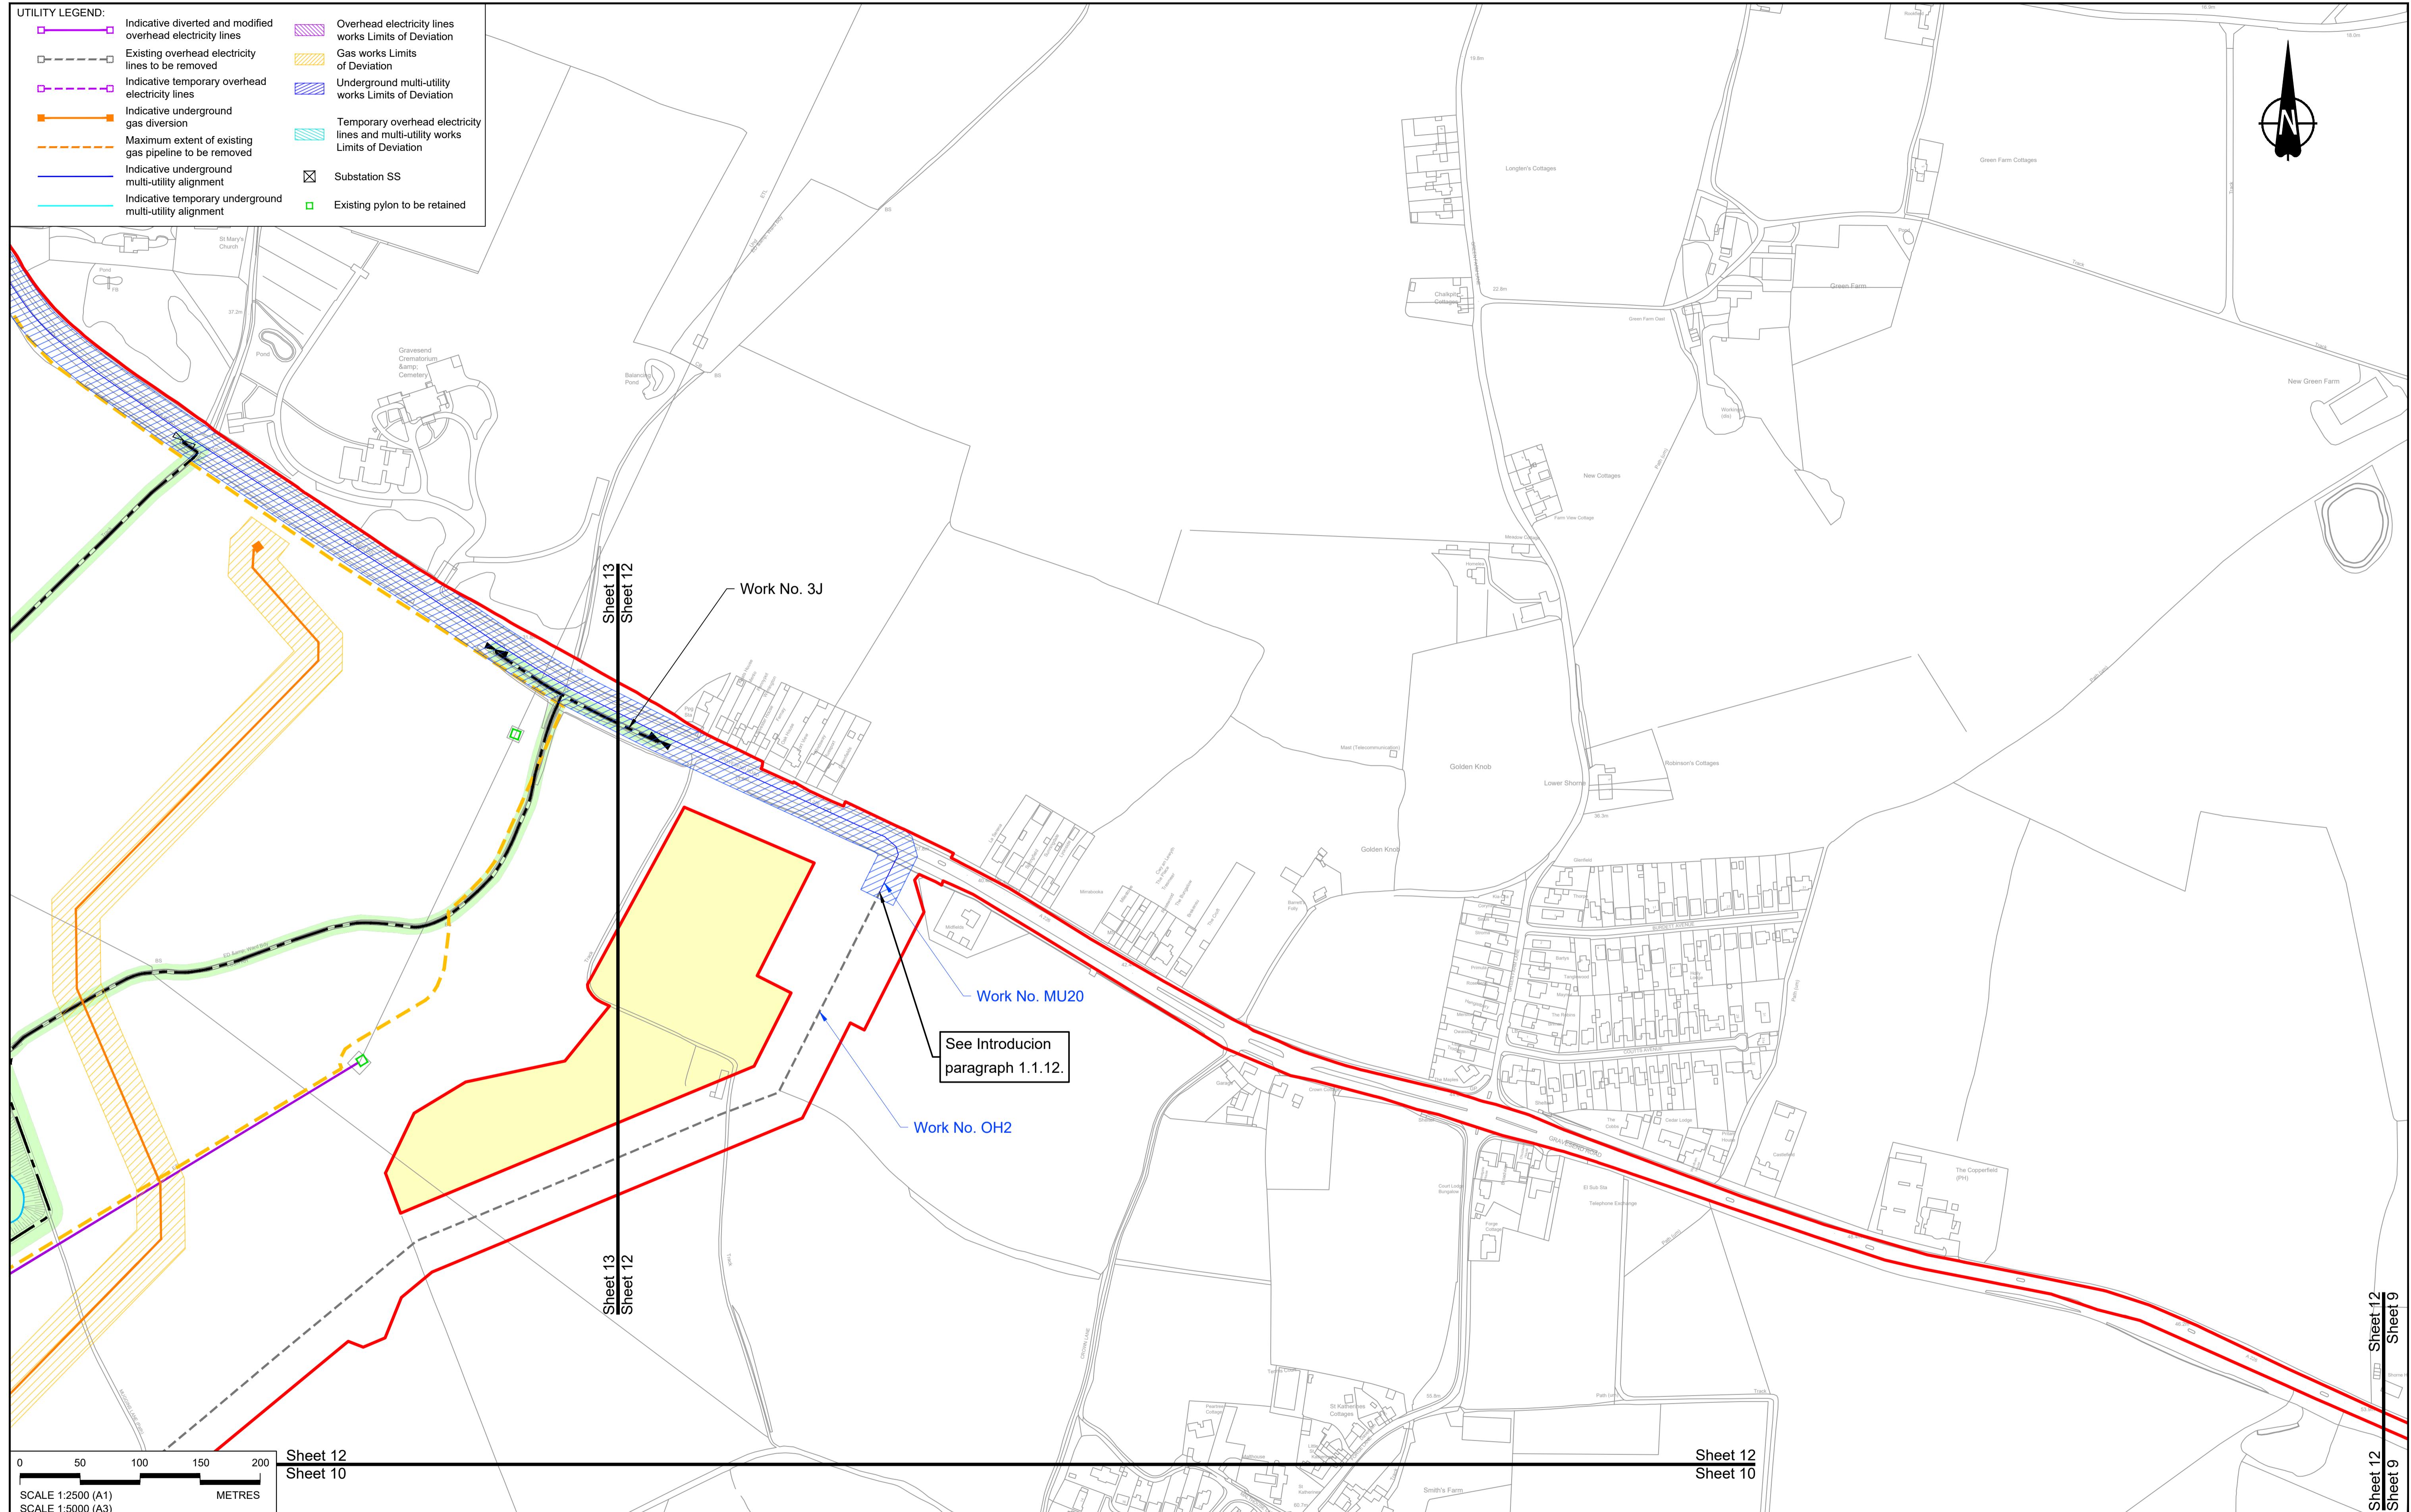


Contains Ordnance Survey data. © Crown copyright and database rights 2022. Ordnance Survey 100030649									
P01	S8	19/10/2022	DCO Application	MS	RO	ASB			
P02	S8	13/12/2022	Revision following S51 advice	MS	RO	ASB			
P03	S8	11/12/2023	Deadline 9	MS	RO	ASB			
Rev	Status	Rev. Date	Purpose of revision	Drawn	Chkd	Apprv'd			

NOTES:

- The proposed works shown are illustrative only and will be subject to change as part of detailed design development. Any changes will be limited to being within the constraints included in the Development Consent Order (application document reference TR010032/APP/3.1).
- These plans should be read in conjunction with Schedule 1 (Authorised Development) of the Development Consent Order (application document reference TR010032/APP/2.2) and the Engineering Drawings and Sections (application document reference TR010032/APP/2.9).
- Proposed works are shown adjacent to the Order Limits to provide greater clarity of the extent of the work but could extend to the Order Limits as well.
- The definition of streets is included in the Development Consent Order (application document reference TR010032/APP/3.1).


LEGEND:

Order Limits	Flood compensation area	Commencement of linear work	Ecological habitat creation and receptor site for protected species
Linear Work Centrelne (including streets)	Culvert	Termination of linear work	Temporary ecological habitat
Local Authority boundary	Bridge/structure	Open space provision, replacement open space or replacement common land	Open space provision, replacement open space or replacement common land
Highway Work (includes structures) Limits of Deviation	Watercourse diversion work centrelne	Bat Barn structure	Bat Barn structure
Area excluded from Order Limits	Infiltration basin, detention basin or retention pond boundary	Construction Area - Utilities Logistic Hub	Travellers site
	Major structure	Construction Area - Main Works Compound	Water inlet with self-regulating valve

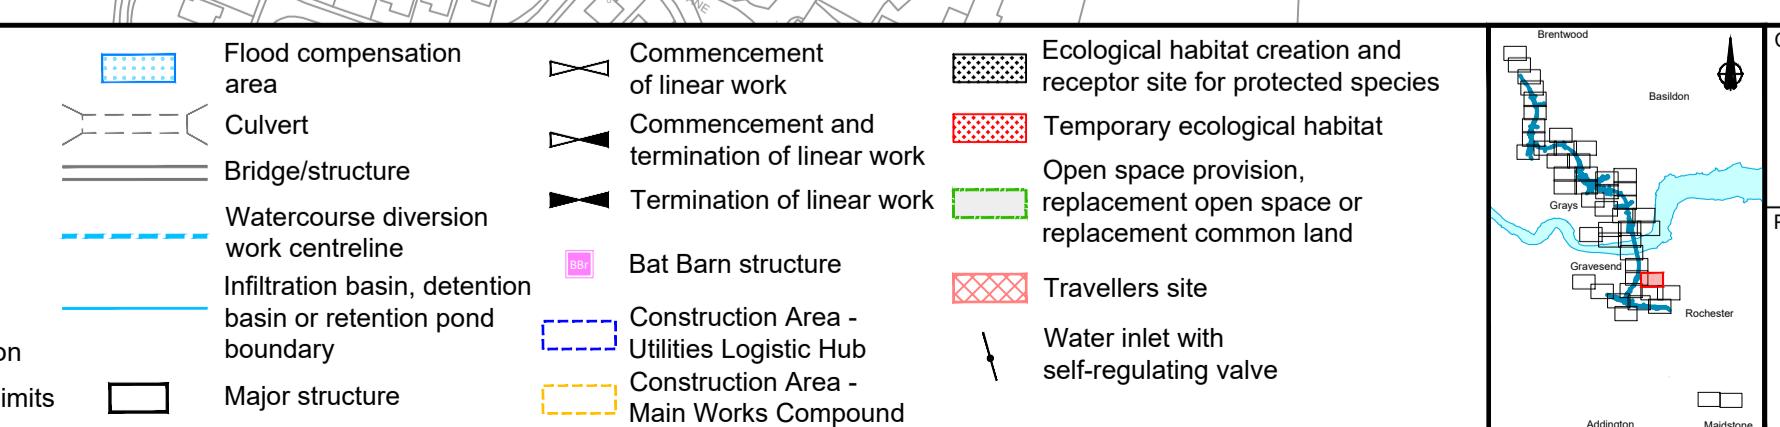

Client: national highways
Project: LOWER THAMES CROSSING

Status: DCO Examination
Original Size: A1
Revision: P03
Application Document Number: TR010032/APP/2.6
Scale: 1:2500
Drawing title: WORKS PLANS REGULATION 5(2)(j)
Project: LOWER THAMES CROSSING SHEET 12 - COMPOSITE
Drawing Number: HE540039-CJV-BOP-SZZ_GN0000000_DR-CX-20057

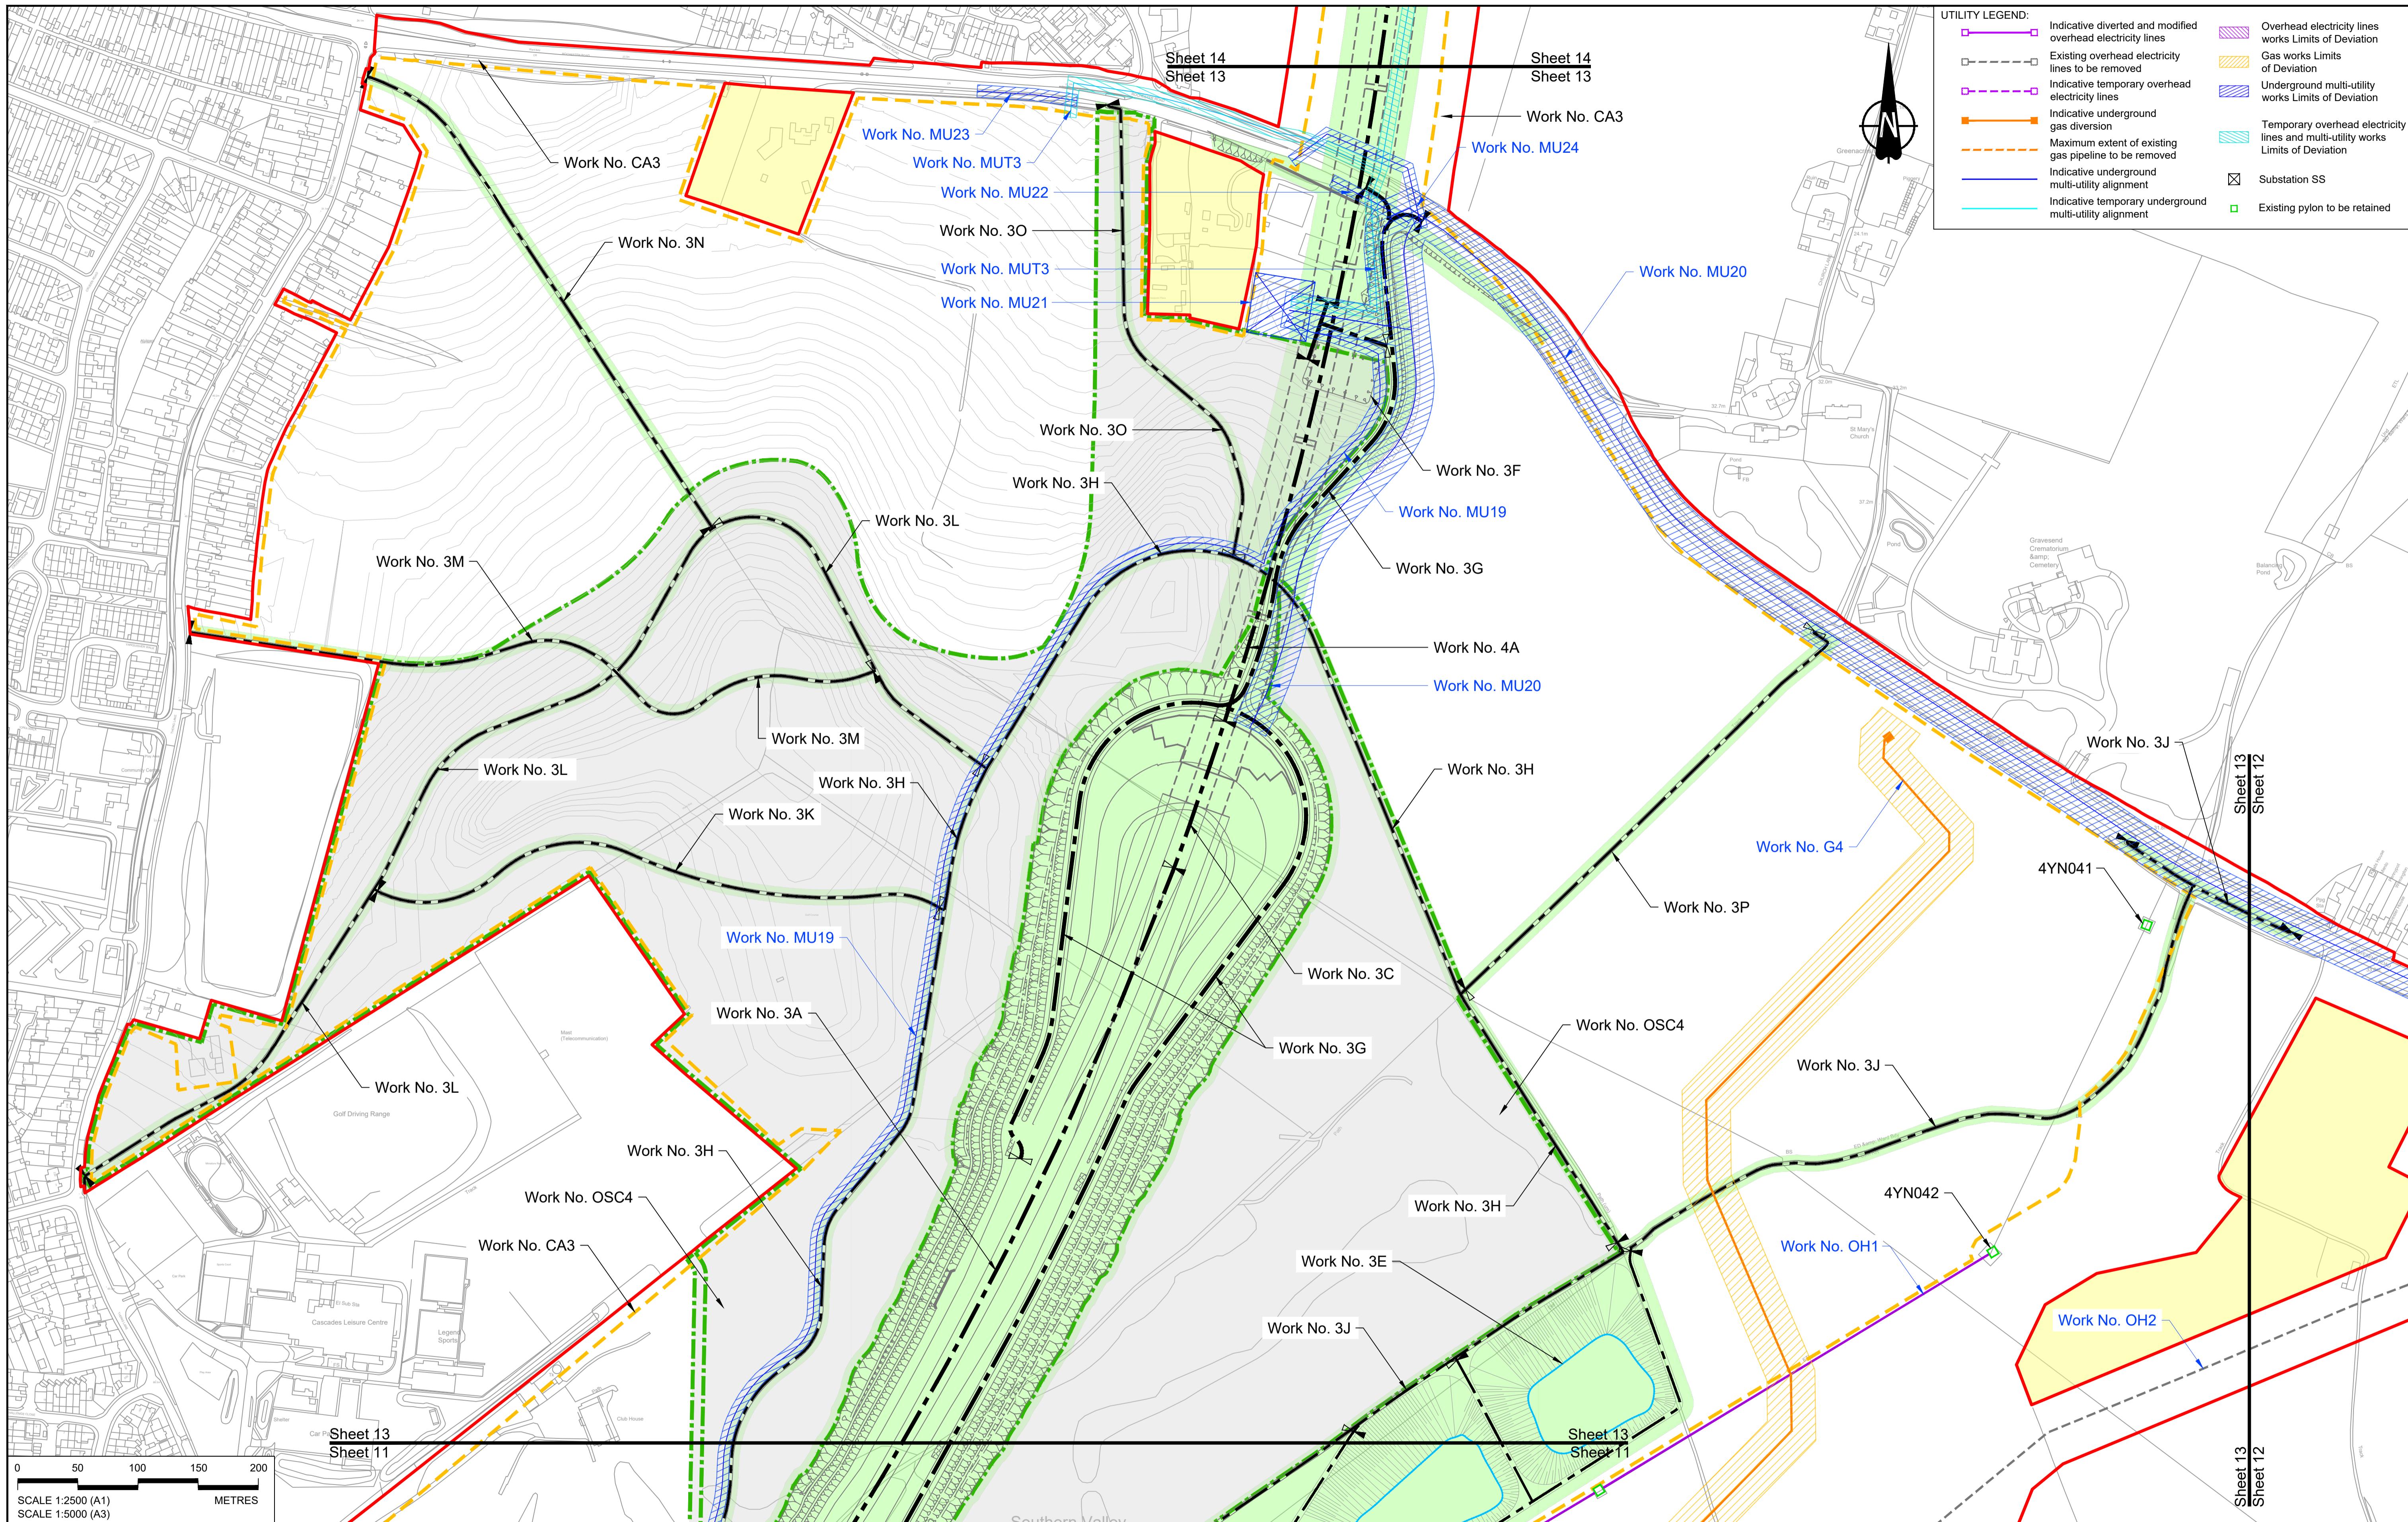

Contains Ordnance Survey data. © Crown copyright and database rights 2022. Ordnance Survey 100030649

P01 S8 19/10/2022 DCO Application MS RO ASB

P02 S8 17/11/2023 Deadline 7 MS RO ASB

P03 S8 11/12/2023 Deadline 9 MS RO ASB

Rev Status Rev. Date Purpose of revision Drawn Chkd Apprv'd

NOTES:

- The proposed works shown are illustrative only and will be subject to change as part of detailed design development. Any changes will be limited to being within the constraints included in the Development Consent Order (application document reference TR010032/APP/3.1).
- These plans should be read in conjunction with Schedule 1 (Authorised Development) of the Development Consent Order (application document reference TR010032/APP/2.2) and the Land Plans (application document reference TR010032/APP/2.2) and the Engineering Drawings and Sections (application document reference TR010032/APP/2.9).
- Proposed works are shown adjacent to the Order Limits to provide greater clarity of the extent of the work but could extend to the Order Limits as well.
- The definition of streets is included in the Development Consent Order (application document reference TR010032/APP/3.1).

LEGEND:

Order Limits	Flood compensation area	Commencement of linear work	Ecological habitat creation and receptor site for protected species
Linear Work Centreline (including streets)	Culvert	Commencement and termination of linear work	Temporary ecological habitat
Local Authority boundary	Bridge/structure	Termination of linear work	Open space provision, replacement open space or replacement common land
Highway Work (includes structures) Limits of Deviation	Watercourse diversion work centreline	Infiltration basin, detention basin or retention pond boundary	Bat Barn structure
	Construction Area - Utilities Logistic Hub	Construction Area - Main Works Compound	Travellers site
			Water inlet with self-regulating valve
			Major structure

LEGEND:

Order Limits	Flood compensation area	Commencement of linear work	Ecological habitat creation and receptor site for protected species
Linear Work Centreline (including streets)	Culvert	Commencement and termination of linear work	Temporary ecological habitat
Local Authority boundary	Bridge/structure	Termination of linear work	Open space provision, replacement open space or replacement common land
Highway Work (includes structures) Limits of Deviation	Watercourse diversion work centreline	Infiltration basin, detention basin or retention pond boundary	Bat Barn structure
	Construction Area - Utilities Logistic Hub	Construction Area - Main Works Compound	Travellers site
			Water inlet with self-regulating valve
			Major structure

LEGEND:

Order Limits	Flood compensation area	Commencement of linear work	Ecological habitat creation and receptor site for protected species
Linear Work Centreline (including streets)	Culvert	Commencement and termination of linear work	Temporary ecological habitat
Local Authority boundary	Bridge/structure	Termination of linear work	Open space provision, replacement open space or replacement common land
Highway Work (includes structures) Limits of Deviation	Watercourse diversion work centreline	Infiltration basin, detention basin or retention pond boundary	Bat Barn structure
	Construction Area - Utilities Logistic Hub	Construction Area - Main Works Compound	Travellers site
			Water inlet with self-regulating valve
			Major structure

LEGEND:

Order Limits	Flood compensation area	Commencement of linear work	Ecological habitat creation and receptor site for protected species
Linear Work Centreline (including streets)	Culvert	Commencement and termination of linear work	Temporary ecological habitat
Local Authority boundary	Bridge/structure	Termination of linear work	Open space provision, replacement open space or replacement common land
Highway Work (includes structures) Limits of Deviation	Watercourse diversion work centreline	Infiltration basin, detention basin or retention pond boundary	Bat Barn structure
	Construction Area - Utilities Logistic Hub	Construction Area - Main Works Compound	Travellers site
			Water inlet with self-regulating valve
			Major structure

LEGEND:

Order Limits	Flood compensation area	Commencement of linear work	Ecological habitat creation and receptor site for protected species
Linear Work Centreline (including streets)	Culvert	Commencement and termination of linear work	Temporary ecological habitat
Local Authority boundary	Bridge/structure	Termination of linear work	Open space provision, replacement open space or replacement common land
Highway Work (includes structures) Limits of Deviation	Watercourse diversion work centreline	Infiltration basin, detention basin or retention pond boundary	Bat Barn structure
	Construction Area - Utilities Logistic Hub	Construction Area - Main Works Compound	Travellers site
			Water inlet with self-regulating valve
			Major structure

LEGEND:

Order Limits	Flood compensation area	Commencement of linear work	Ecological habitat creation and receptor site for protected species
Linear Work Centreline (including streets)	Culvert	Commencement and termination of linear work	Temporary ecological habitat
Local Authority boundary	Bridge/structure	Termination of linear work	Open space provision, replacement open space or replacement common land
Highway Work (includes structures) Limits of Deviation	Watercourse diversion work centreline	Infiltration basin, detention basin or retention pond boundary	Bat Barn structure
	Construction Area - Utilities Logistic Hub	Construction Area - Main Works Compound	Travellers site
			Water inlet with self-regulating valve
			Major structure

LEGEND:


Order Limits	Flood compensation area	Commencement of linear work	Ecological habitat creation and receptor site for protected species
Linear Work Centreline (including streets)	Culvert	Commencement and termination of linear work	Temporary ecological habitat
Local Authority boundary	Bridge/structure	Termination of linear work	Open space provision, replacement open space or replacement common land
Highway Work (includes structures) Limits of Deviation	Watercourse diversion work centreline	Infiltration basin, detention basin or retention pond boundary	Bat Barn structure
	Construction Area - Utilities Logistic Hub	Construction Area - Main Works Compound	Travellers site
			Water inlet with self-regulating valve
			Major structure

LEGEND:

Order Limits	Flood compensation area	Commencement of linear work	Ecological habitat creation and receptor site for protected species
Linear Work Centreline (including streets)	Culvert	Commencement and termination of linear work	Temporary ecological habitat
Local Authority boundary	Bridge/structure	Termination of linear work	Open space provision, replacement open space or replacement common land
Highway Work (includes structures) Limits of Deviation	Watercourse diversion work centreline	Infiltration basin, detention basin or retention pond boundary	Bat Barn structure
	Construction Area - Utilities Logistic Hub	Construction Area - Main Works Compound	Travellers site
			Water inlet with self-regulating valve
			Major structure

LEGEND:

Order Limits	Flood compensation area	Commencement of linear work	Ecological habitat creation and receptor site for protected species
Linear Work Centreline (including streets)	Culvert	Commencement and termination of linear work	Temporary ecological habitat
Local Authority boundary	Bridge/structure	Termination of linear work	Open space provision, replacement open space or replacement common land
Highway Work (includes structures) Limits of Deviation	Watercourse diversion work centreline	Infiltration basin, detention basin or retention pond boundary	Bat Barn structure
	Construction Area - Utilities Logistic Hub	Construction Area - Main Works Compound	Travellers site
			Water inlet with self-regulating valve
			Major structure

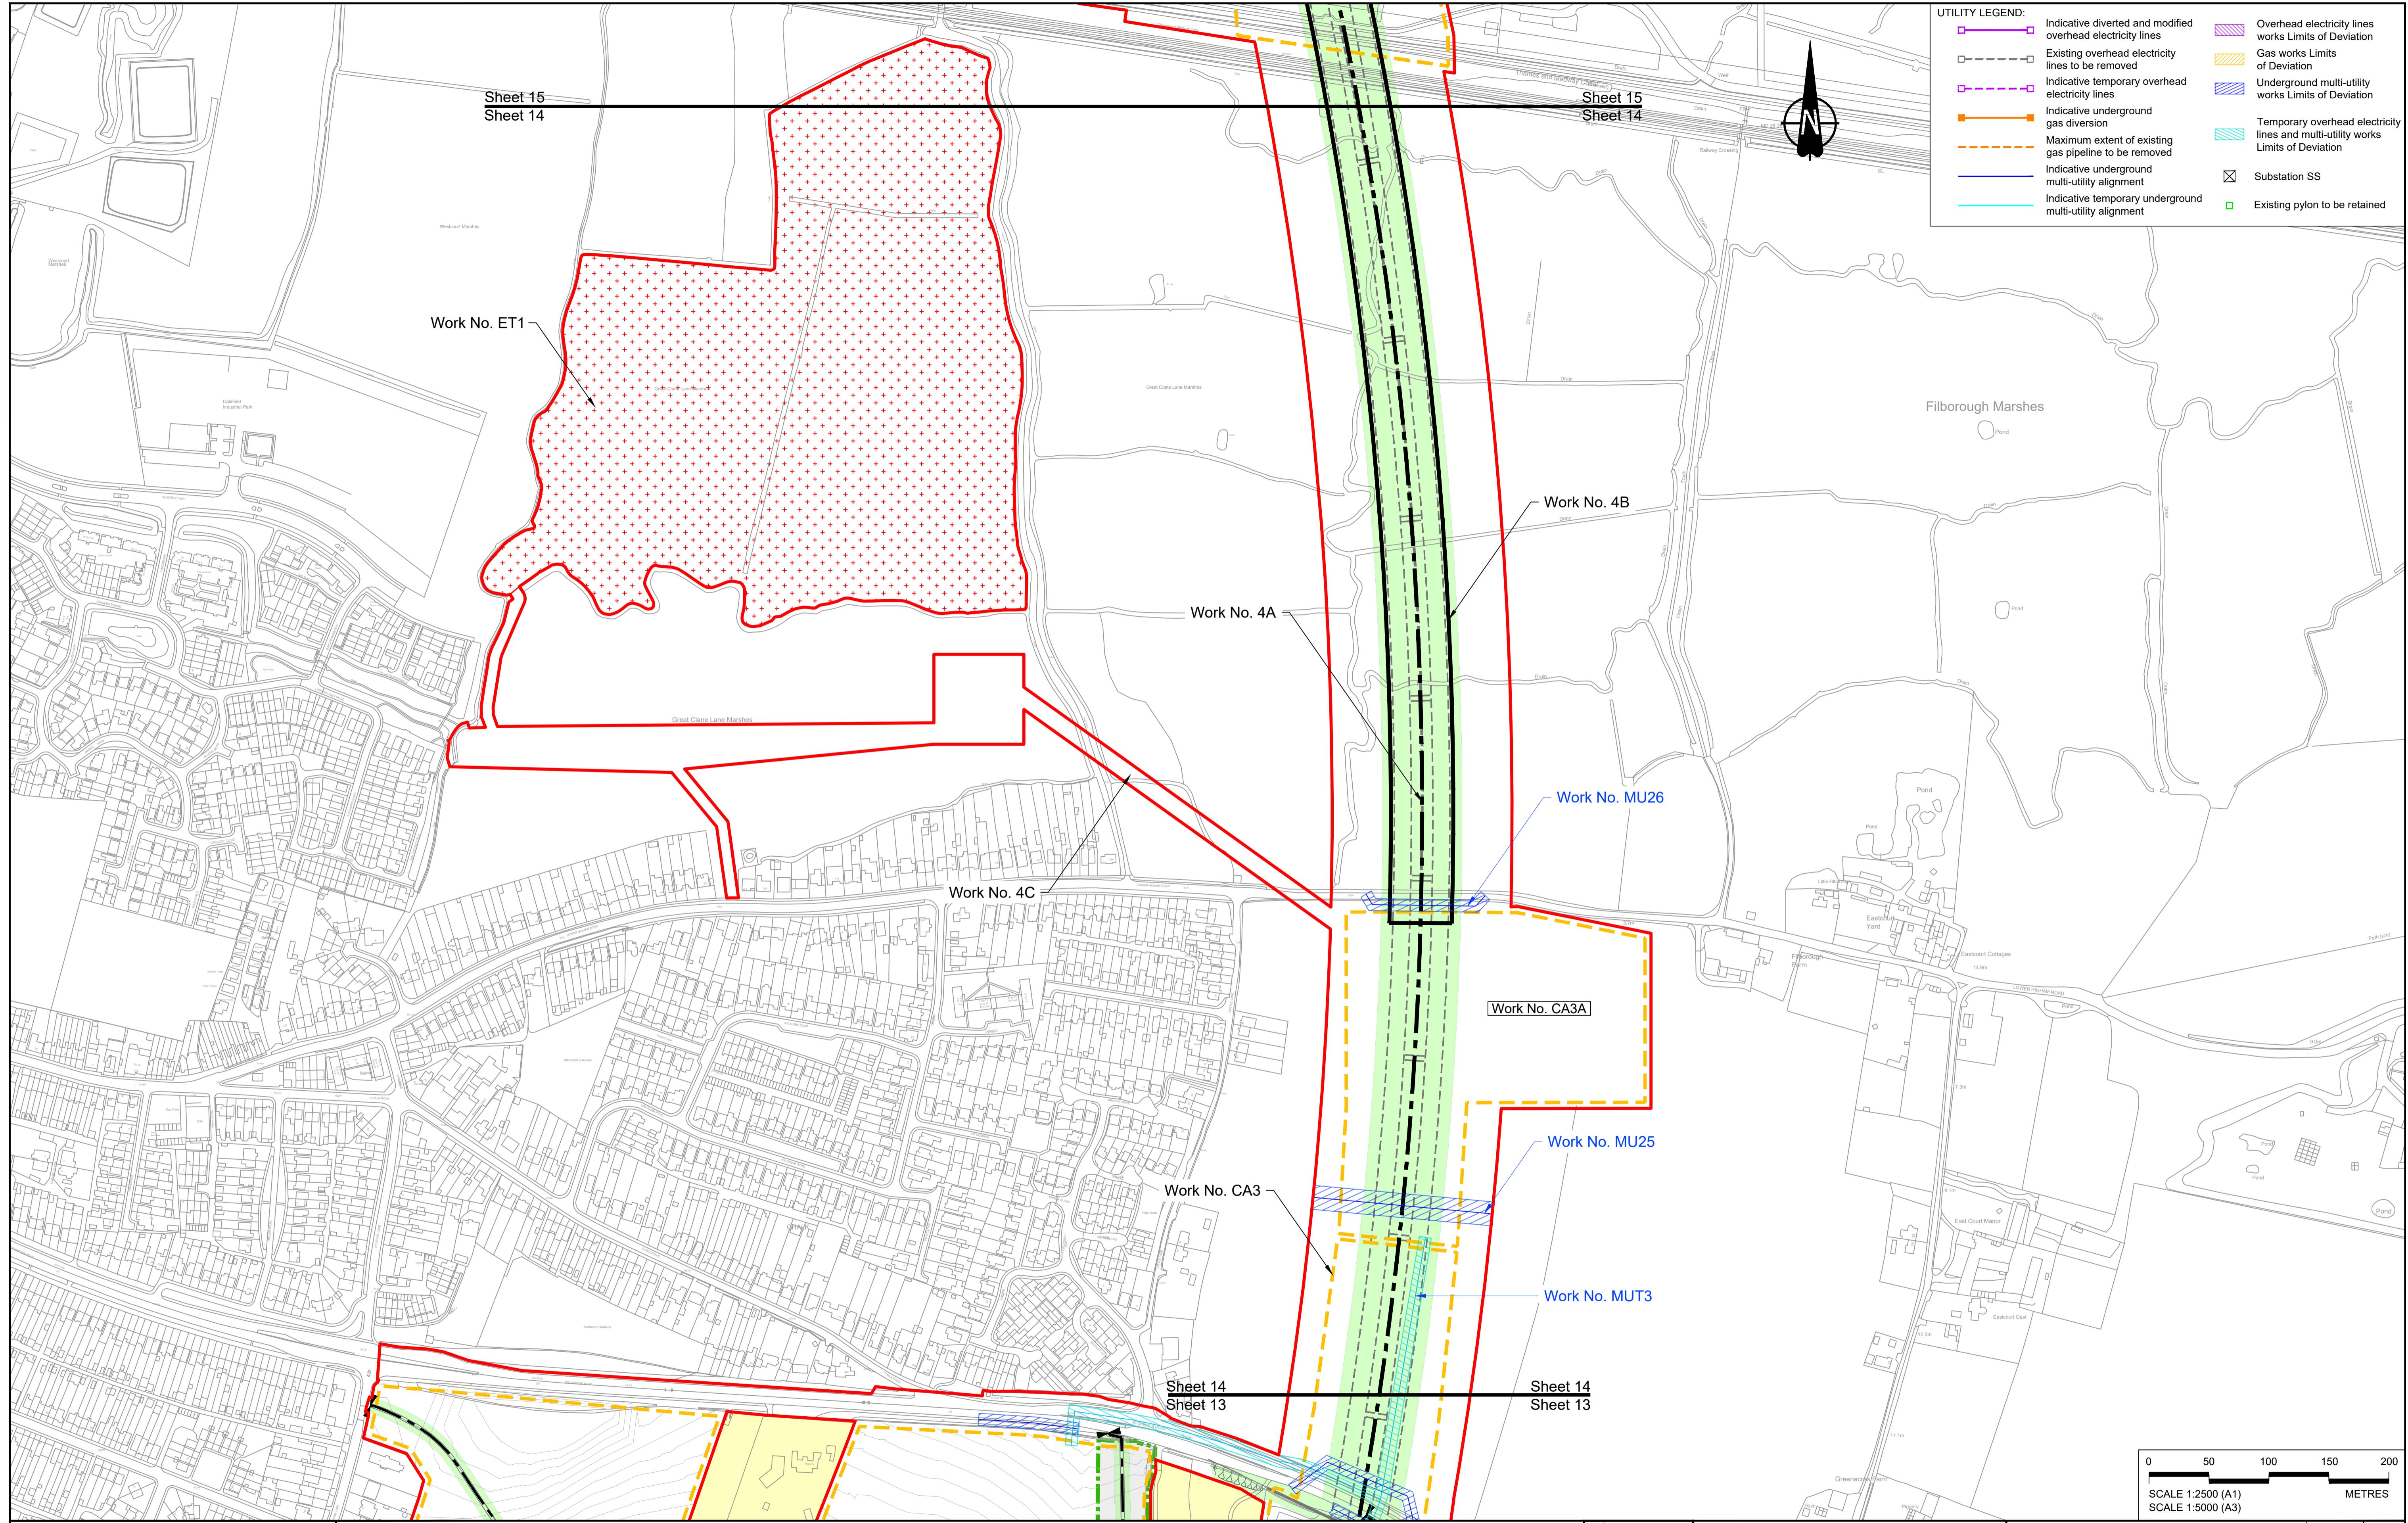

Contains Ordnance Survey data. © Crown copyright and database rights 2022. Ordnance Survey 100030649									
NOTES:									
P01	S8	19/10/2022	DCO Application	MS	RO	ASB			
P02	S8	13/12/2022	Revision following S51 advice	MS	RO	ASB			
P03	S8	11/12/2023	Deadline 9	MS	RO	ASB			
Rev	Status	Rev. Date	Purpose of revision	Drawn	Chkd	Apprv'd			

LEGEND:



- Order Limits
- Linear Work Centrelne (including streets)
- Local Authority boundary
- Highway Work (includes structures) Limits of Deviation
- Area excluded from Order Limits

1. The proposed works shown are illustrative only and will be subject to change as part of detailed design development. Any changes will be limited to being within the constraints included in the Development Consent Order (application document reference TR010032/APP3.1).

2. These plans should be read in conjunction with Schedule 1 (Authorised Development) of the Development Consent Order (application document reference TR010032/APP3.1), the Land Plans (application document reference TR010032/APP2.2) and the Engineering Drawings and Sections (application document reference TR010032/APP2.9).


3. Proposed works are shown adjacent to the Order Limits to provide greater clarity of the extent of the work but could extend to the Order Limits as well.


4. The definition of streets is included in the Development Consent Order (application document reference TR010032/APP3.1).

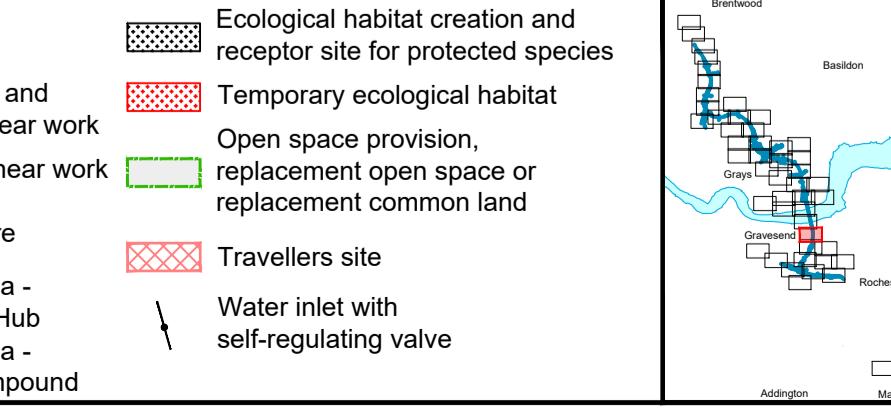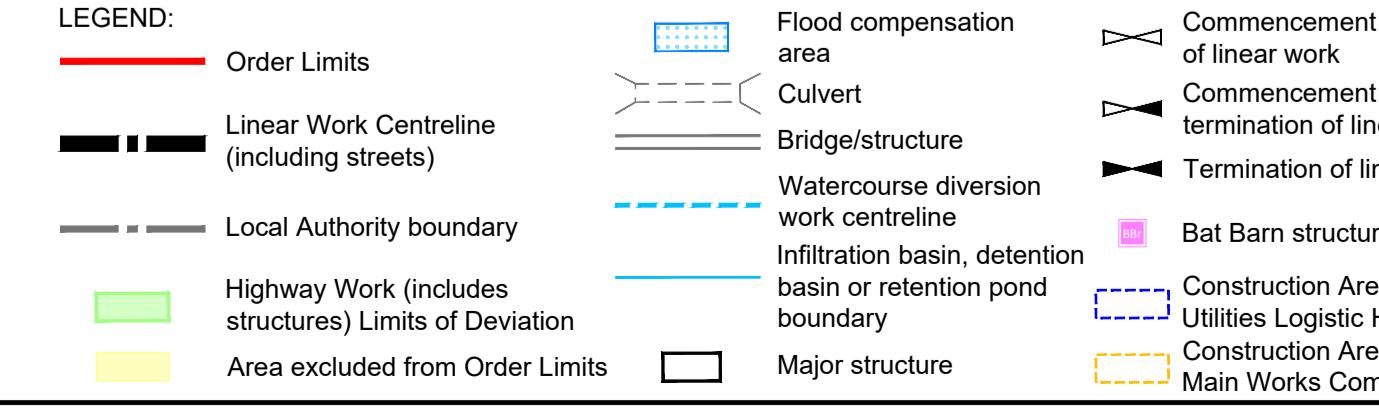


Project
LOWER THAMES CROSSING

DCO Examination
TR010032/APP/2.6
Scale 1:2500
WORKS PLANS
REGULATION 5(2)(j)
SHEET 14 - COMPOSITE
Drawing Number HE540039-CJV-BOP-SZZ_GN0000000_DR-CX-20011

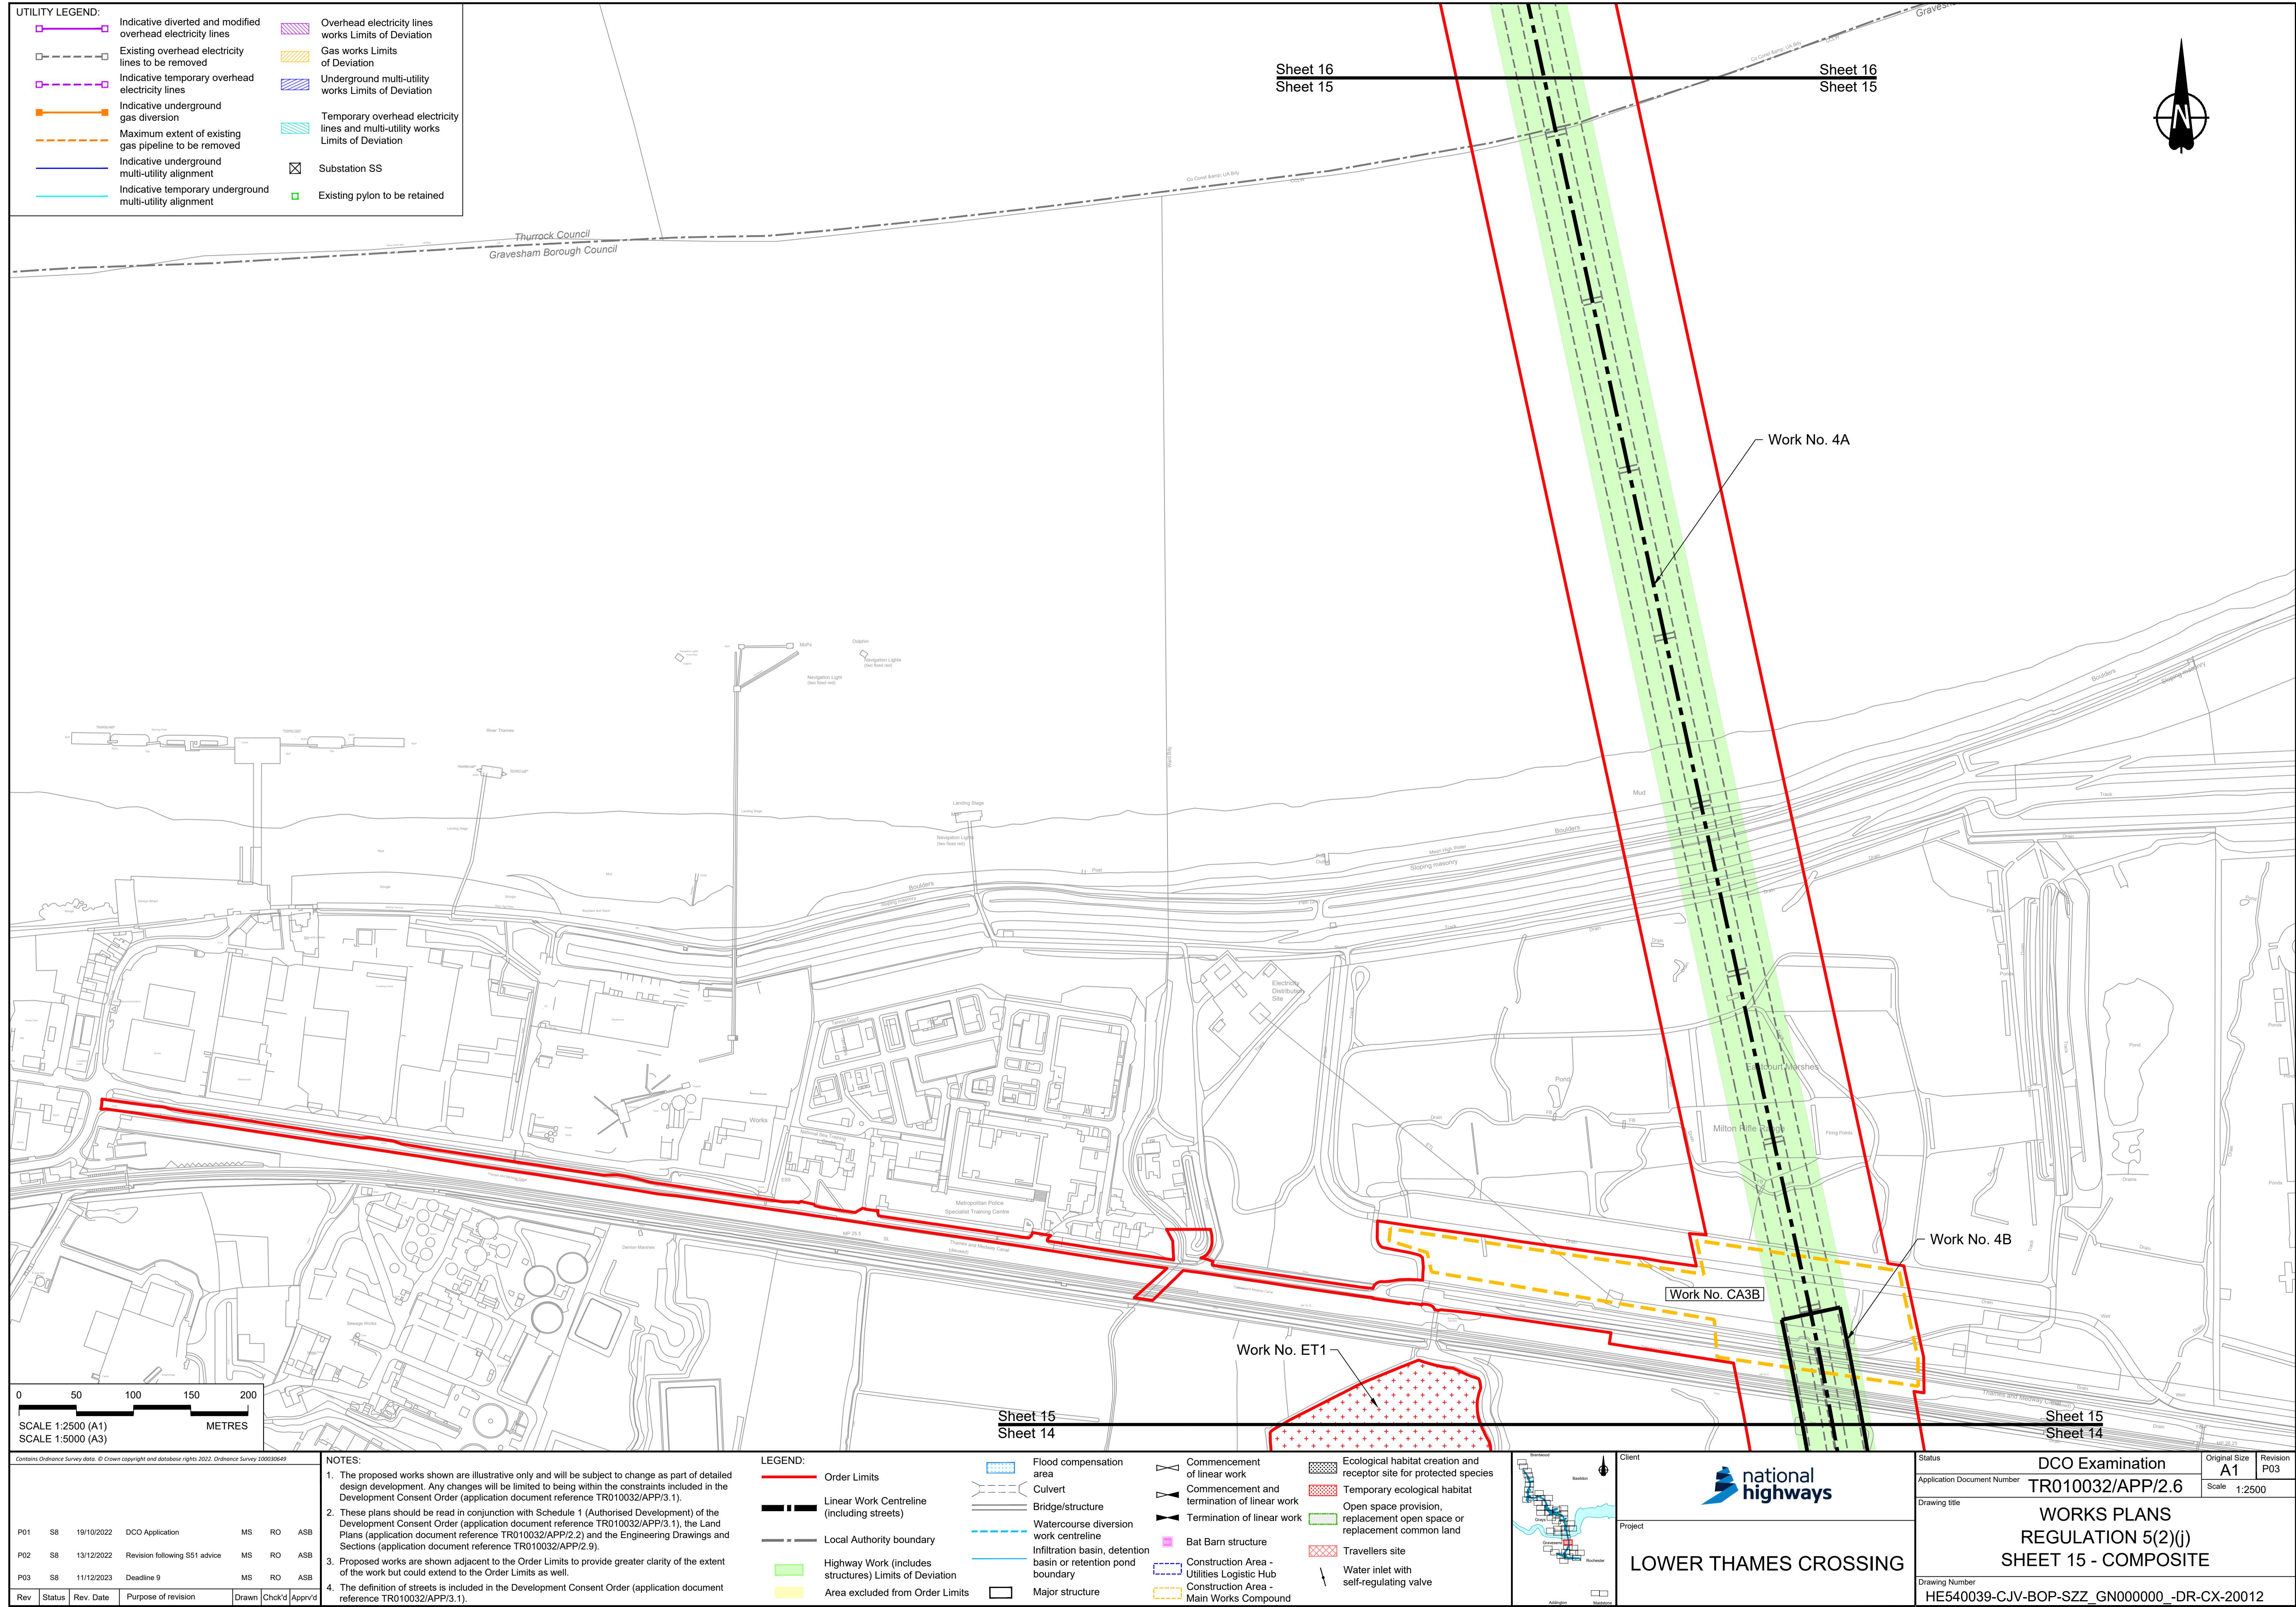

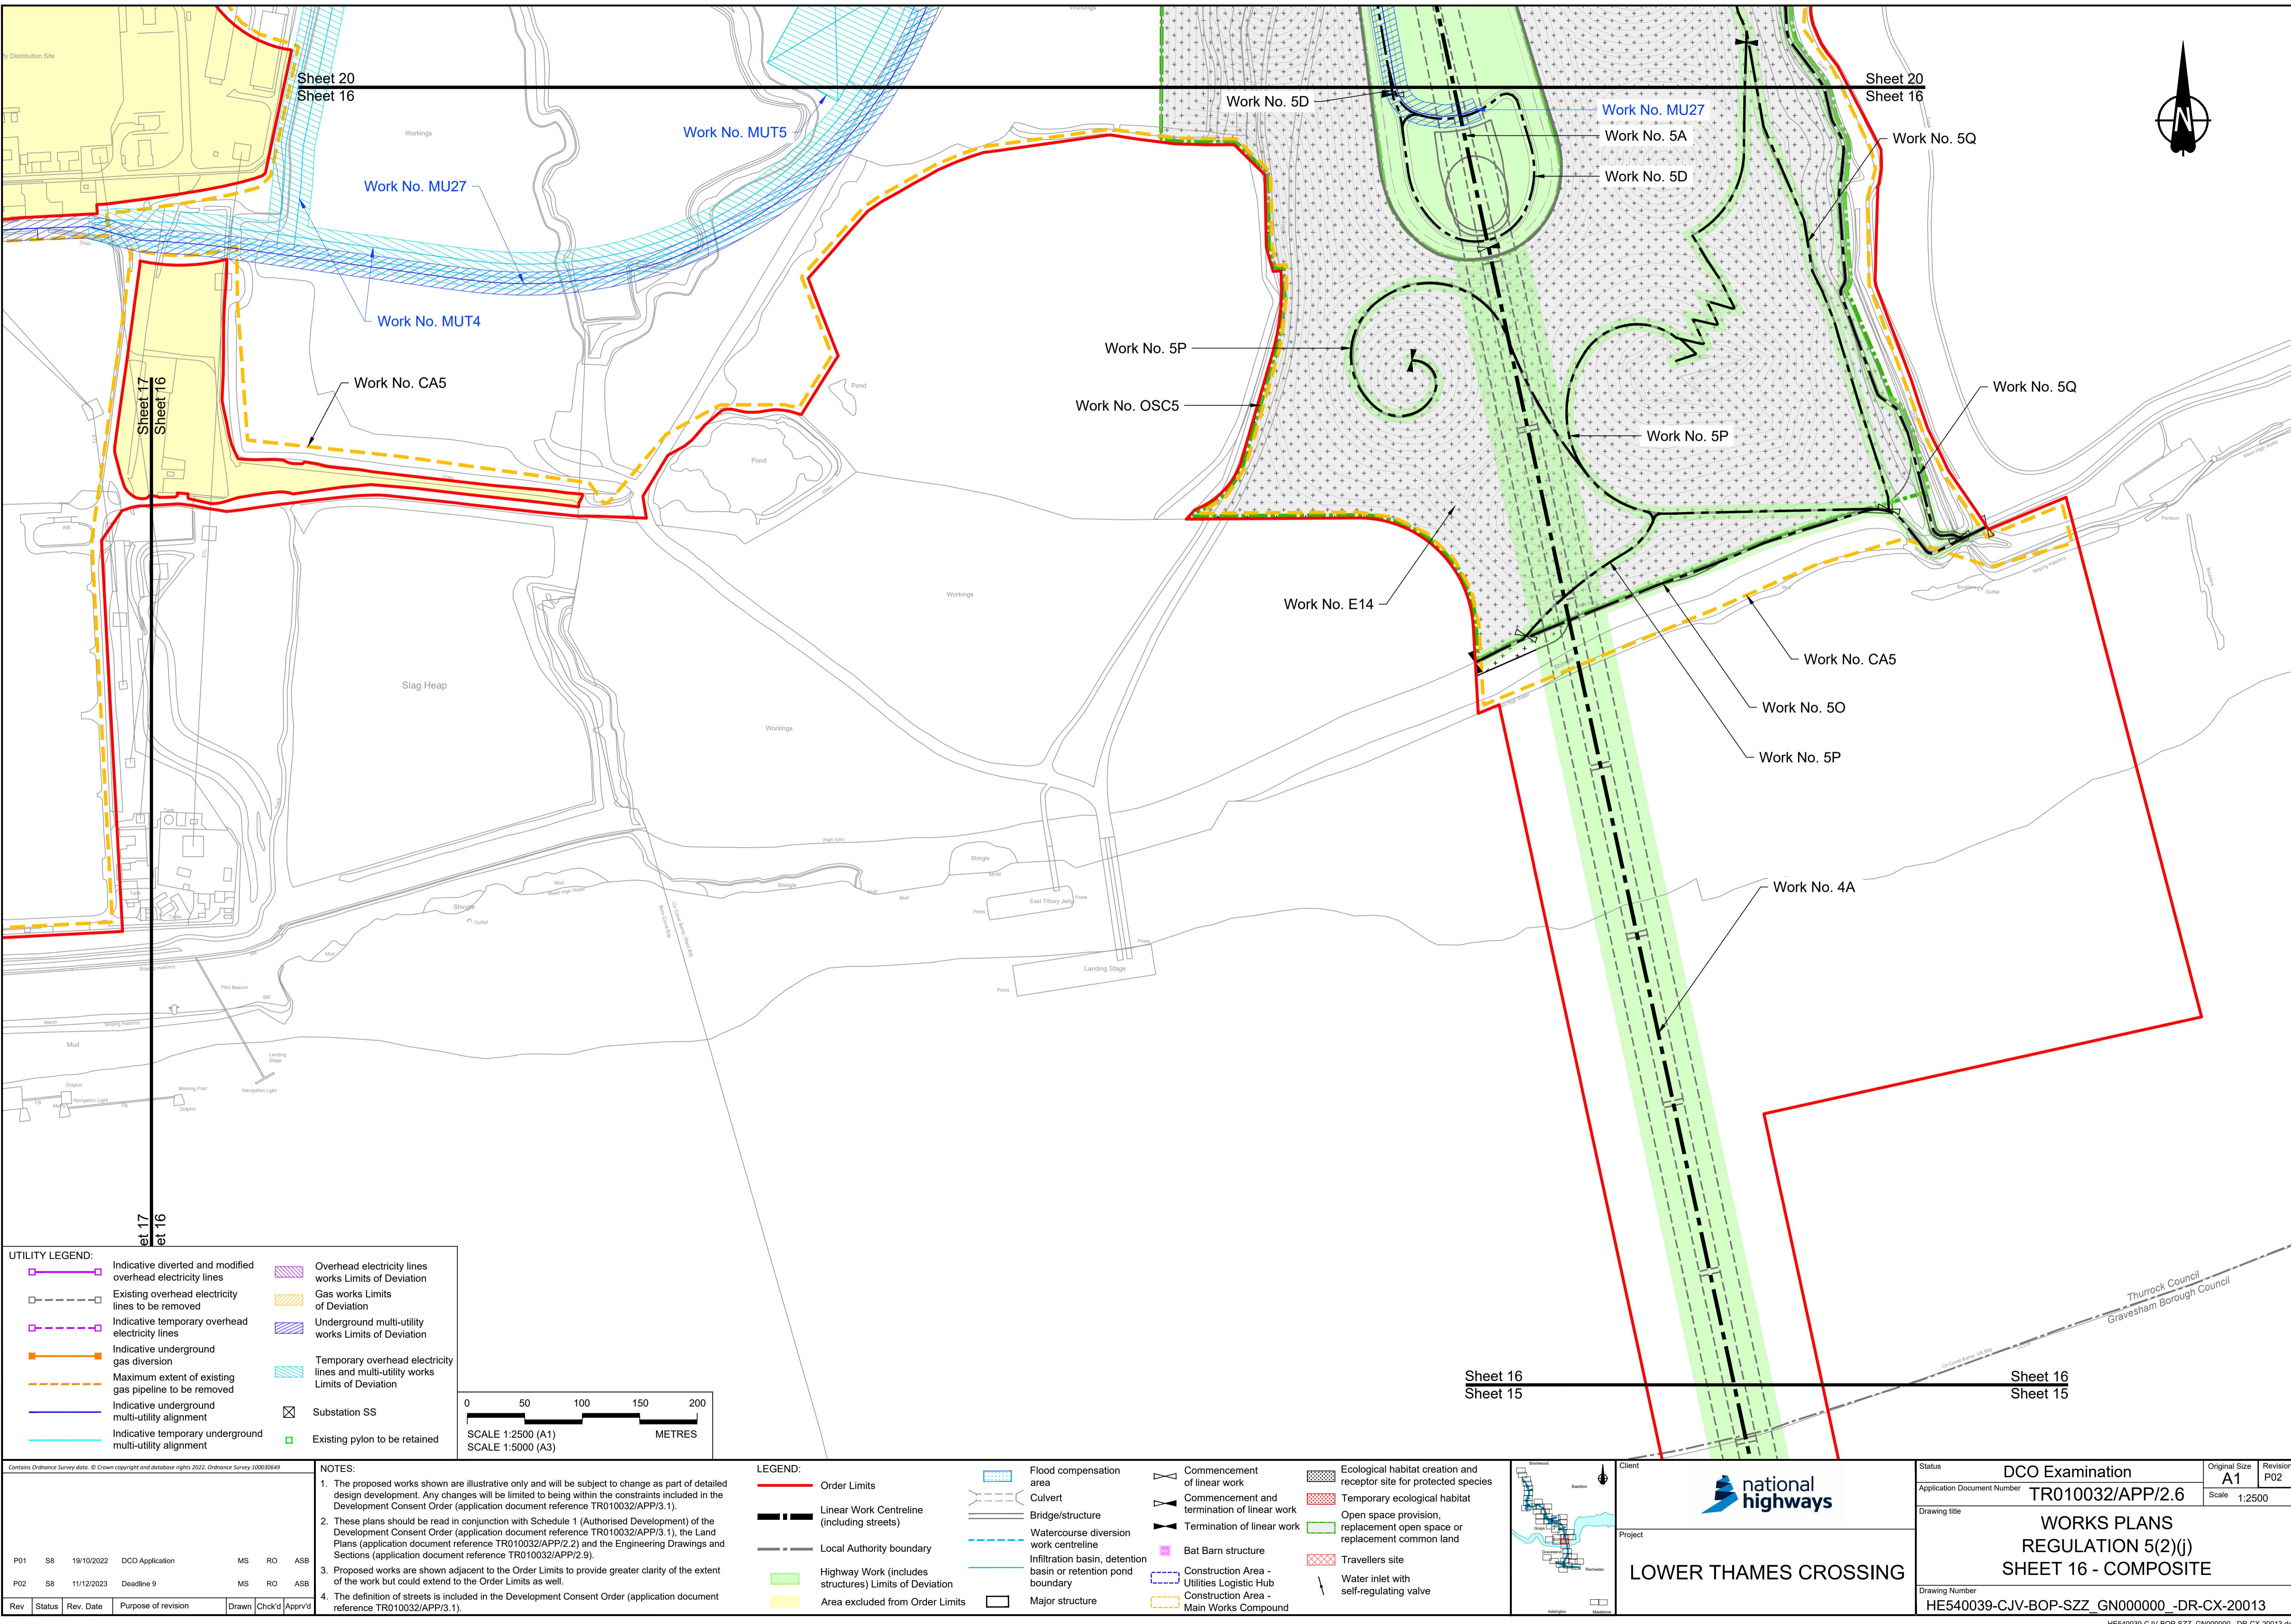


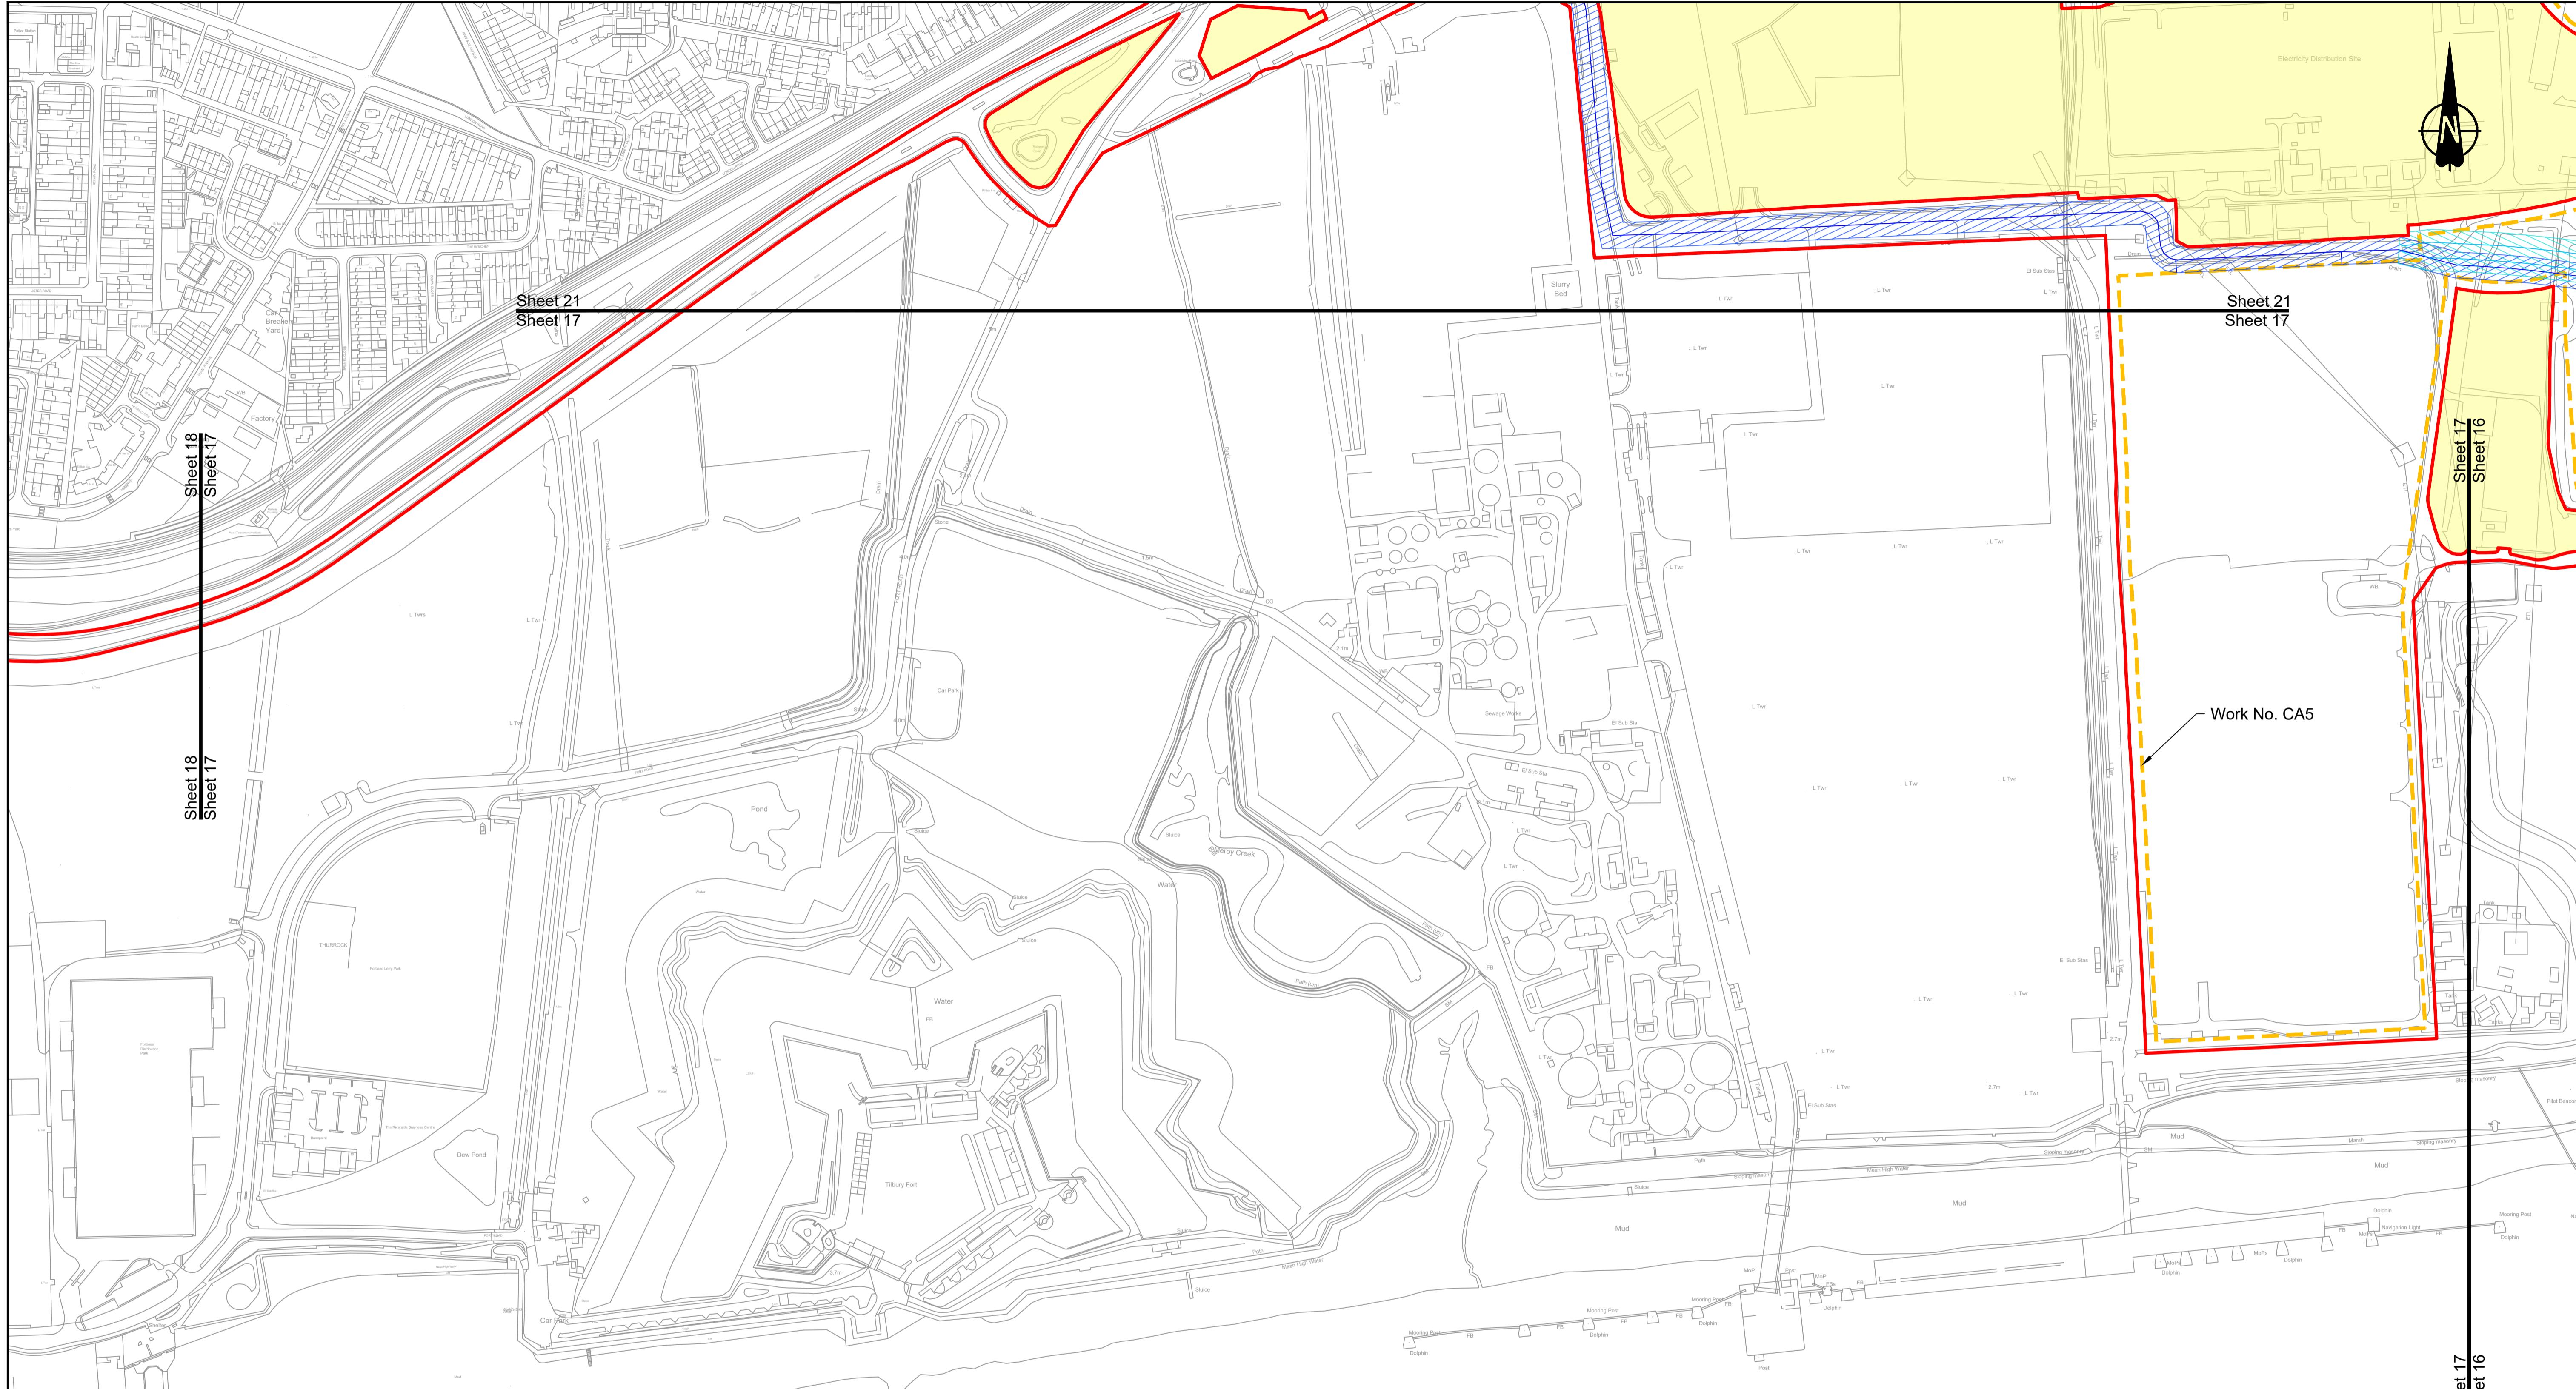

Contains Ordnance Survey data. © Crown copyright and database rights 2022. Ordnance Survey 100030649											
NOTES:											
1. The proposed works shown are illustrative only and will be subject to change as part of detailed design development. Any changes will be limited to being within the constraints included in the Development Consent Order (application document reference TR010032/APP/3.1).											
2. These plans should be read in conjunction with Schedule 1 (Authorised Development) of the Development Consent Order (application document reference TR010032/APP/2.2) and the Land Plans (application document reference TR010032/APP/3.1), the Engineering Drawings and Sections (application document reference TR010032/APP/2.9), and the Engineering Drawings and Sections (application document reference TR010032/APP/3.1).											
3. Proposed works are shown adjacent to the Order Limits to provide greater clarity of the extent of the work but could extend to the Order Limits as well.											
4. The definition of streets is included in the Development Consent Order (application document reference TR010032/APP/3.1).											
P01	S8	19/10/2022	DCO Application	MS	RO	ASB					
P02	S8	17/11/2023	Deadline 7	MS	RO	ASB					
P03	S8	11/12/2023	Deadline 9	MS	RO	ASB					
Rev	Status	Rev. Date	Purpose of revision	Drawn	Chk'd	Apprv'd					


LEGEND:
— Order Limits
— Linear Work Centreline (including streets)
— Local Authority boundary
— Highway Work (includes structures) Limits of Deviation
— Flood compensation area
— Culvert
— Bridge/structure
— Watercourse diversion work centreline
— Infiltration basin, detention basin or retention pond boundary
— Area excluded from Order Limits
— Commencement of linear work
— Commencement and termination of linear work
— Termination of linear work
■ Bat Barn structure
■ Travellers site
— Construction Area - Utilities Logistic Hub
— Construction Area - Main Works Compound
□ Major structure

LEGEND:
— Order Limits
— Linear Work Centreline (including streets)
— Local Authority boundary
— Highway Work (includes structures) Limits of Deviation
— Flood compensation area
— Culvert
— Bridge/structure
— Watercourse diversion work centreline
— Infiltration basin, detention basin or retention pond boundary
— Area excluded from Order Limits
— Commencement of linear work
— Commencement and termination of linear work
— Termination of linear work
■ Bat Barn structure
■ Travellers site
— Construction Area - Utilities Logistic Hub
— Construction Area - Main Works Compound
□ Major structure

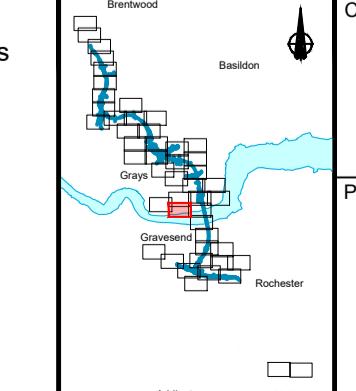

Client:
national highways
 Project:
LOWER THAMES CROSSING

Status:
DCO Examination
 Application Document Number: **TR010032/APP/2.6**
 Scale: **1:2500**
 Drawing title:
WORKS PLANS
REGULATION 5(2)(j)
SHEET 17 - COMPOSITE
 Drawing Number: **HE540039-CJV-BOP-SZZ_GN000000_DR-CX-20014**

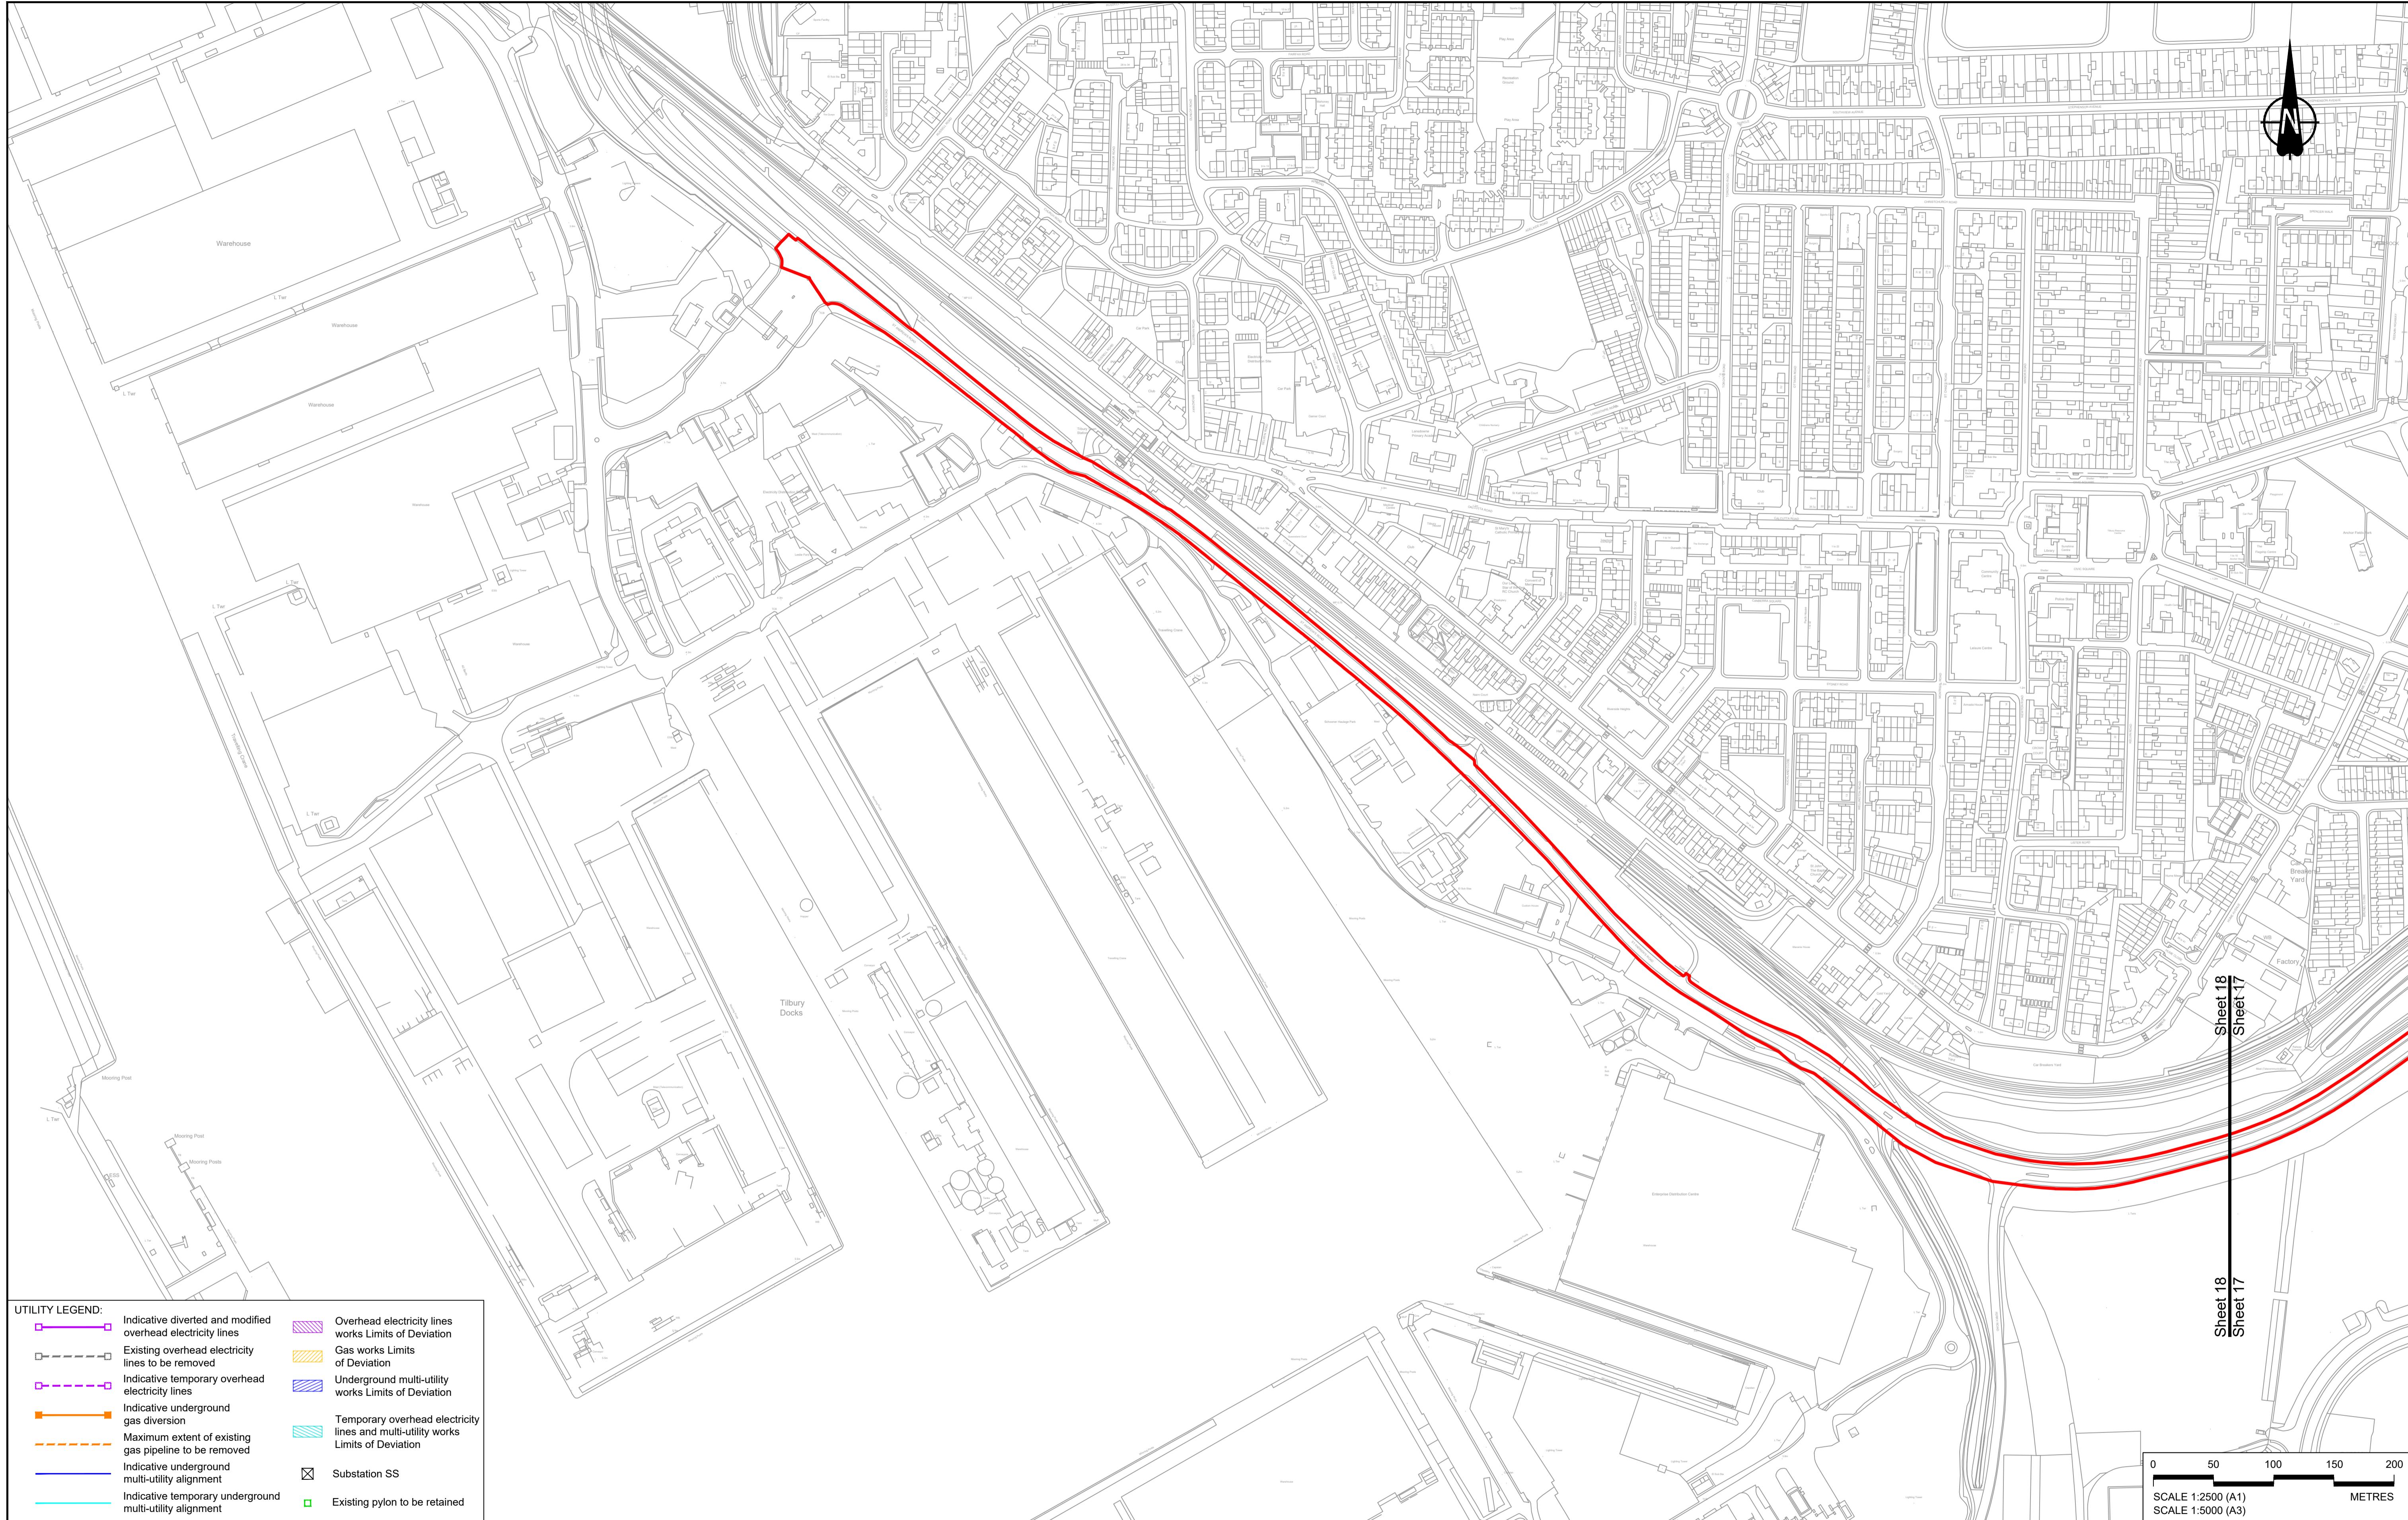

Contains Ordnance Survey data. © Crown copyright and database rights 2022. Ordnance Survey 100030649

- NOTES:**
- The proposed works shown are illustrative only and will be subject to change as part of detailed design development. Any changes will be limited to being within the constraints included in the Development Consent Order (application document reference TR010032/APP/1).
 - These plans should be read in conjunction with Schedule 1 (Authorised Development) of the Development Consent Order (application document reference TR010032/APP/3.1), the Land Plans (application document reference TR010032/APP/2.2) and the Engineering Drawings and Sections (application document reference TR010032/APP/2.9).
 - Proposed works are shown adjacent to the Order Limits to provide greater clarity of the extent of the work but could extend to the Order Limits as well.
 - The definition of streets is included in the Development Consent Order (application document reference TR010032/APP/3.1).

- LEGEND:**
- Order Limits
 - Linear Work Centreline (including streets)
 - Local Authority boundary
 - Highway Work (includes structures) Limits of Deviation
 - Area excluded from Order Limits
 - Flood compensation area
 - Culvert
 - Bridge/structure
 - Watercourse diversion work centreline
 - Infiltration basin, detention basin or retention pond boundary
 - Major structure
 - Commencement of linear work
 - Commencement and termination of linear work
 - Termination of linear work
 - Bat Barn structure
 - Construction Area - Utilities Logistic Hub
 - Construction Area - Main Works Compound
 - Ecological habitat creation and receptor site for protected species
 - Temporary ecological habitat
 - Open space provision, replacement open space or replacement common land
 - Travellers site
 - Water inlet with self-regulating valve

Client
national highways
Project
LOWER THAMES CROSSING

Status
DCO Examination

Original Size
A1

Revision
P02


Scale
1:2500


Drawing title
WORKS PLANS

REGULATION 5(2)(j)

SHEET 18 - COMPOSITE

Drawing Number
HE540039-CJV-BOP-SZZ_GN000000_DR-CX-20015

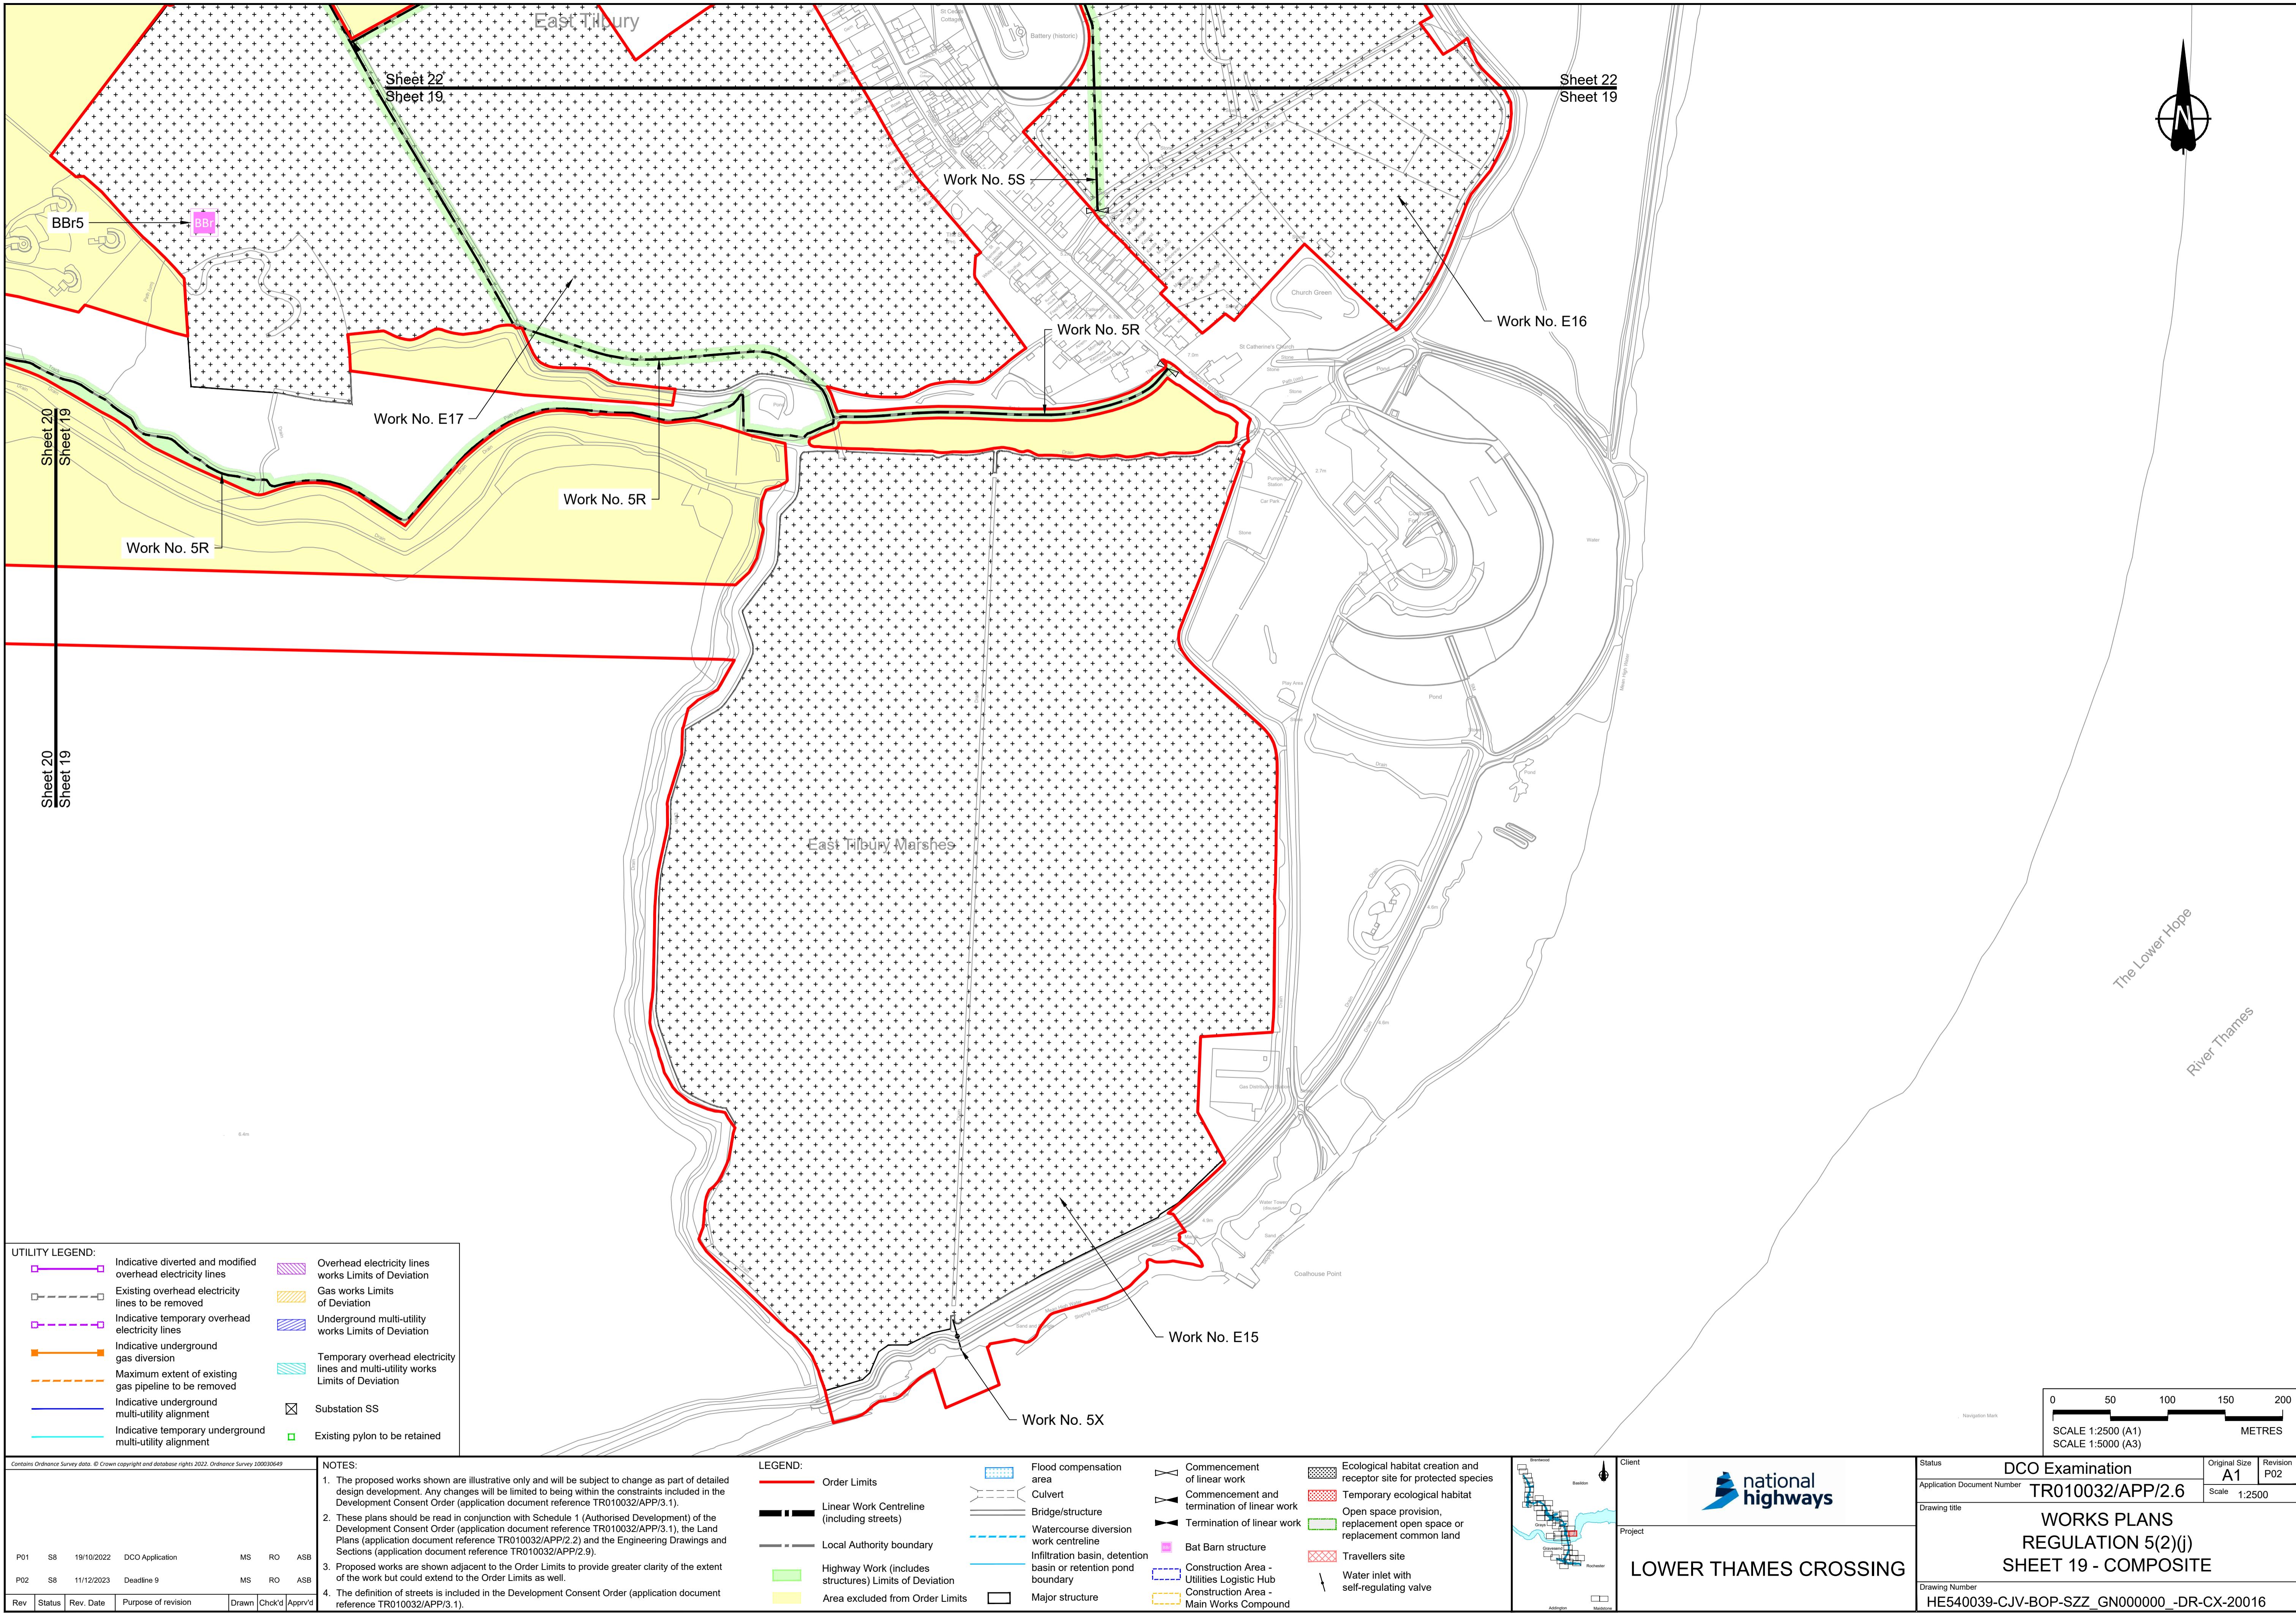

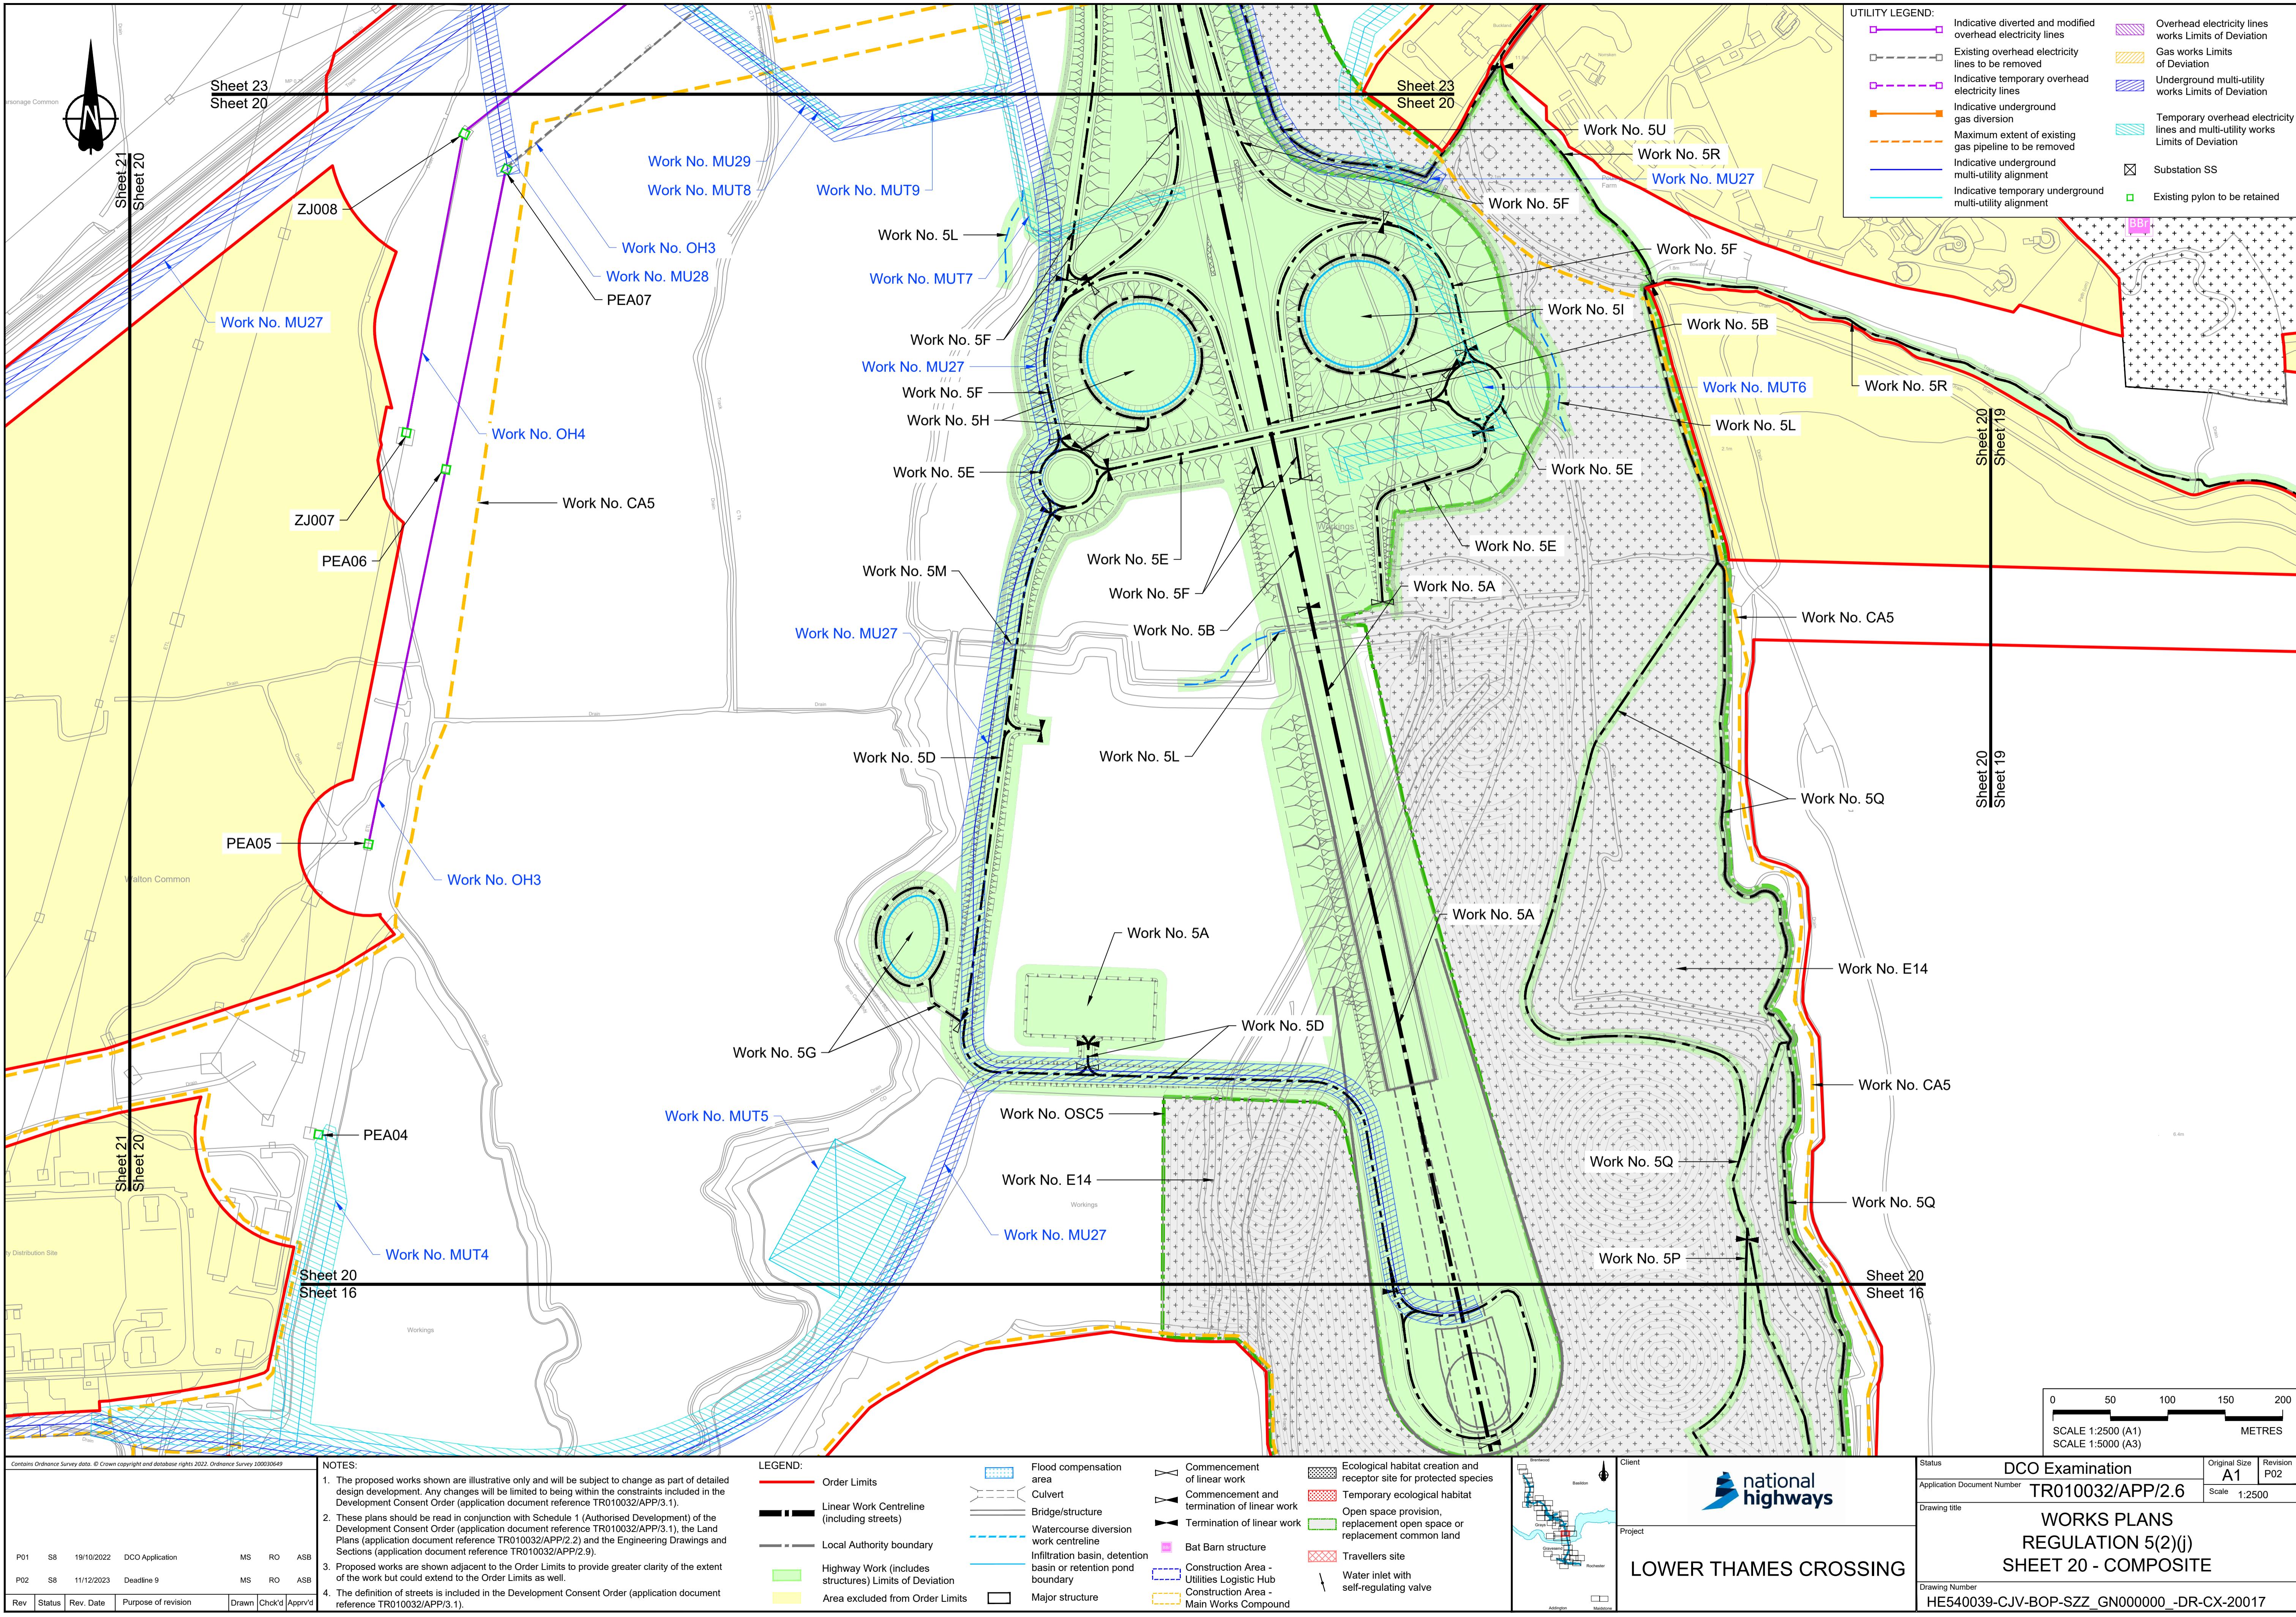

If you need help accessing this or any other National Highways information, please call **0300 123 5000** and we will help you.

© Crown copyright 2023.

You may re-use this information (not including logos) free of charge in any format or medium, under the terms of the Open Government Licence. To view this licence:

visit www.nationalarchives.gov.uk/doc/open-government-licence/

write to the **Information Policy Team, The National Archives, Kew, London TW9 4DU**,
or email psi@nationalarchives.gsi.gov.uk.

Mapping (where present): © Crown copyright and database rights 2023 OS 100030649. You are permitted to use this data solely to enable you to respond to, or interact with, the organisation that provided you with the data. You are not permitted to copy, sub-licence, distribute or sell any of this data to third parties in any form.

If you have any enquiries about this publication email info@nationalhighways.co.uk or call **0300 123 5000***.

*Calls to 03 numbers cost no more than a national rate call to an 01 or 02 number and must count towards any inclusive minutes in the same way as 01 and 02 calls.

These rules apply to calls from any type of line including mobile, BT, other fixed line or payphone. Calls may be recorded or monitored.

Printed on paper from well-managed forests and other controlled sources when issued directly by National Highways.

Registered office Bridge House, 1 Walnut Tree Close, Guildford GU1 4LZ

National Highways Limited registered in England and Wales number 09346363